general notes

- 1. IT SHALL BE THE RESPONSIBILITY OF THE CONTRACTOR OR PERMITTEE TO CONTACT "UNDERGROUND SERVICE ALERT U.S.A." TOLL FREE AT 1-800-227-2600 FORTY-EIGHT (48) HOURS PRIOR TO START OF CONSTRUCTION, FOR LOCATION OF POWER, TELEPHONE, OIL AND NATURAL GAS UNDERGROUND FACILITIES. CONTRACTOR OR PERMITEE SHALL ALSO CONTACT THE APPROPRIATE AGENCY FOR THE LOCATION OF CABLE T.V., WATER, SEWER, DRAINAGE OR UNDERGROUND FACILITIES.
- 2. THE CONTRACTOR SHALL POSSESS A CLASS "A" LICENSE AT THE TIME THE CONTRACT IS AWARDED.

Yetric datum: (not used)

HORIZONTAL CONTROL FOR POINTS _____ & ___ AS PUBLISHED IN THE CITY OF SAN LUIS OBISPO 1999 HORIZONTAL CONTROL NETWORK. CITY NETWORK IS BASED ON THE NORTH AMERICAN DATUM OF 1983 (NAD83) EPOCH DATE 1991.35, ZONE 5 CALIFORNIA.

VERTICAL CONTROL BENCHMARK NO.(S) _____ & ____ AS PUBLISHED IN THE CITY OF SAN LUIS OBISPO 1996
BENCHMARK SYSTEM. CITY'S BENCHMARK SYSTEM IS
GENERALLY 52MM HIGHER THAN THE NORTH AMERICA
VERTICAL DATUM OF 1929 (NAVD29).

PROJECT DIRECTORY

OWNED:

City of San Luis Obispo 955 Morro Street San Luis Obispo, CA 93401 805 781-7200

ARCHITECTS: Fraser Seiple Architects 971 Osos Street San Luis Obispo, CA 93401

PROJECT DATA

ADDRESS: Cerro Romauldo Avenue at Cuesta Drive

ASSESSOR'S PARCEL NUMBER: 052-031-001

---- Lete A. D. D.

LEGAL DESCRIPTION: Lots A - D, Breed's Addition, City of San Luis Obispo

GENERAL PLAN DESIGNATION: Public Facilities

ZONE:

STORIES:

PROPOSED USE:

Restroom

BUILDING AREA:

23 square meters (248 square feet)


MAXIMUM HEIGHT:

4.11 meters (13'-6")

UBC OCCUPANCY GROUP:

Group S, Division 2

SPRINKLERS:

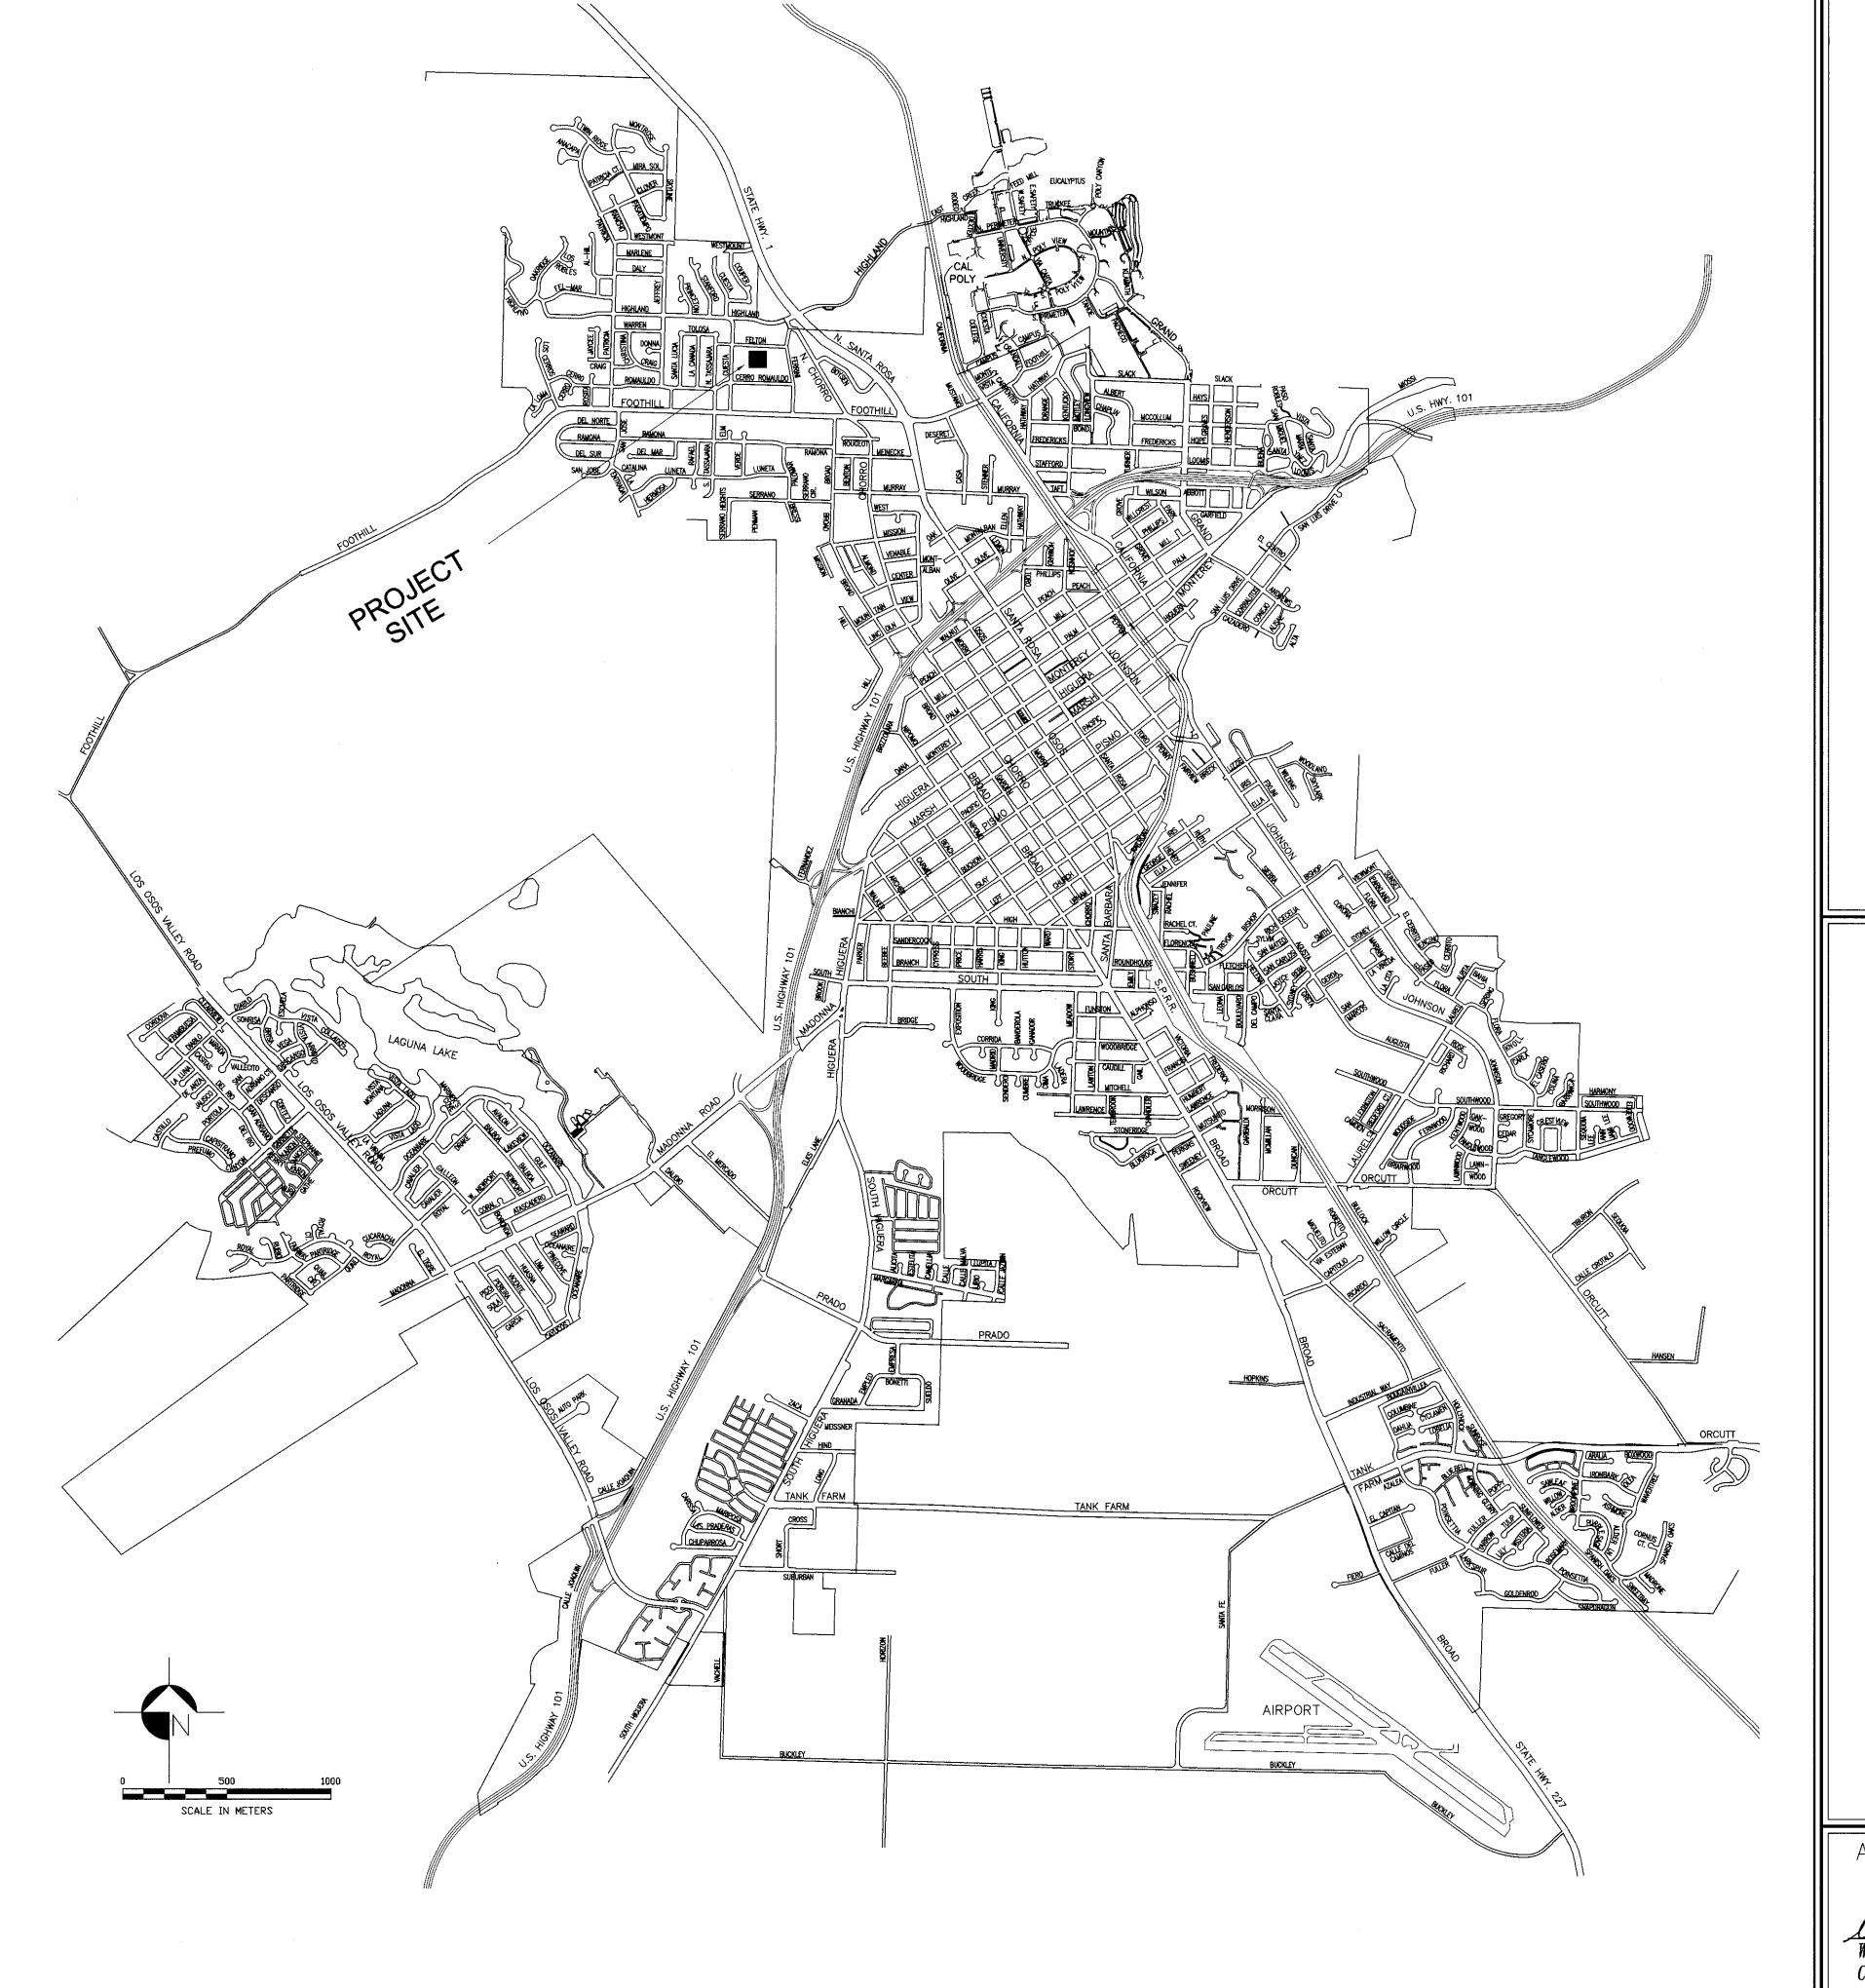

index to plans

T-1 TITLE, COVER SHEET

A-1 SITE PLAN

A-2 FLOOR PLAN, EXTERIOR ELEVATIONS


A-3 STRUCTURAL PLANS, SECTION

A-4 DETAILS

P-1 PLUMBING PLAN, NOTES

E-1 ELECTRICAL PLAN, NOTES



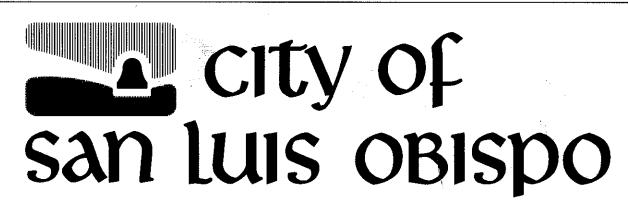

san luis obispo county, california

NEW RESTROOM FOR THROOP PARK

510 CERRO ROMAULDO SAN LUIS OBISPO, CA

SPECIFICATION NO.


99828

APPROVED BY

Wayne A. Peterson City Engineer

R.C.E. 18598



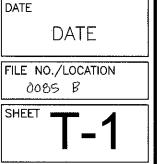

general notes

- 1. IT SHALL BE THE RESPONSIBILITY OF THE CONTRACTOR OR PERMITTEE TO CONTACT "UNDERGROUND SERVICE ALERT U.S.A." TOLL FREE AT 1-800-227-2600 FORTY-EIGHT (48) HOURS PRIOR TO START OF CONSTRUCTION, FOR LOCATION OF POWER, TELEPHONE, OIL AND NATURAL GAS UNDERGROUND FACILITIES. CONTRACTOR OR PERMITEE SHALL ALSO CONTACT THE APPROPRIATE AGENCY FOR THE LOCATION OF CABLE T.V., WATER, SEWER, DRAINAGE OR UNDERGROUND FACILITIES.
- 2. THE CONTRACTOR SHALL POSSESS A CLASS "A" LICENSE AT THE TIME THE CONTRACT IS AWARDED.
- 3. SPECIAL INSPECTION FOR STRUCTURAL WELDING REQUIRED PER ADENDUM #1.



HORIZONTAL CONTROL FOR POINTS _____ & ____ AS PUBLISHED IN THE CITY OF SAN LUIS OBISPO 1999 HORIZONTAL CONTROL NETWORK, CITY NETWORK IS BASED ON THE NORTH AMERICAN DATUM OF 1983 (NAD83) EPOCH DATE 1991.35, ZONE 5 CALIFORNIA.

VERTICAL CONTROL BENCHMARK NO.(S) _____ & ____ AS PUBLISHED IN THE CITY OF SAN LUIS OBISPO 1996 BENCHMARK SYSTEM. CITY'S BENCHMARK SYSTEM IS GENERALLY 52MM HIGHER THAN THE NORTH AMERICA VERTICAL DATUM OF 1929 (NAVD29).

PROJECT DIRECTORY

City of San Luis Oblaco 955 Morro Street San Luis Obispo, CA 93401 805 781-7200

ARCHITECTS: Freser Salpha Architects San Luis Obiepo, CA 93401 806 544-6161

PROJECT DATA

ADDRESS:

Cerro Romauldo Avenue at Cuesta Drive

052-031-001 ASSESSOR'S PARCEL NUMBER:

Lots A - D, Breed's Addition, City of San Luis Obispo LEGAL DESCRIPTION:

Public Facilities GENERAL PLAN DESIGNATION:

PROPOSED USE

23 square meters (248 square feet)

Stories:


BUILDING AREA:

4.11 meters (13'-6") MAXIMUM HEIGHT:

Group S, Division 2


UBC CONSTRUCTION TYPE:

SPRINKLERS:

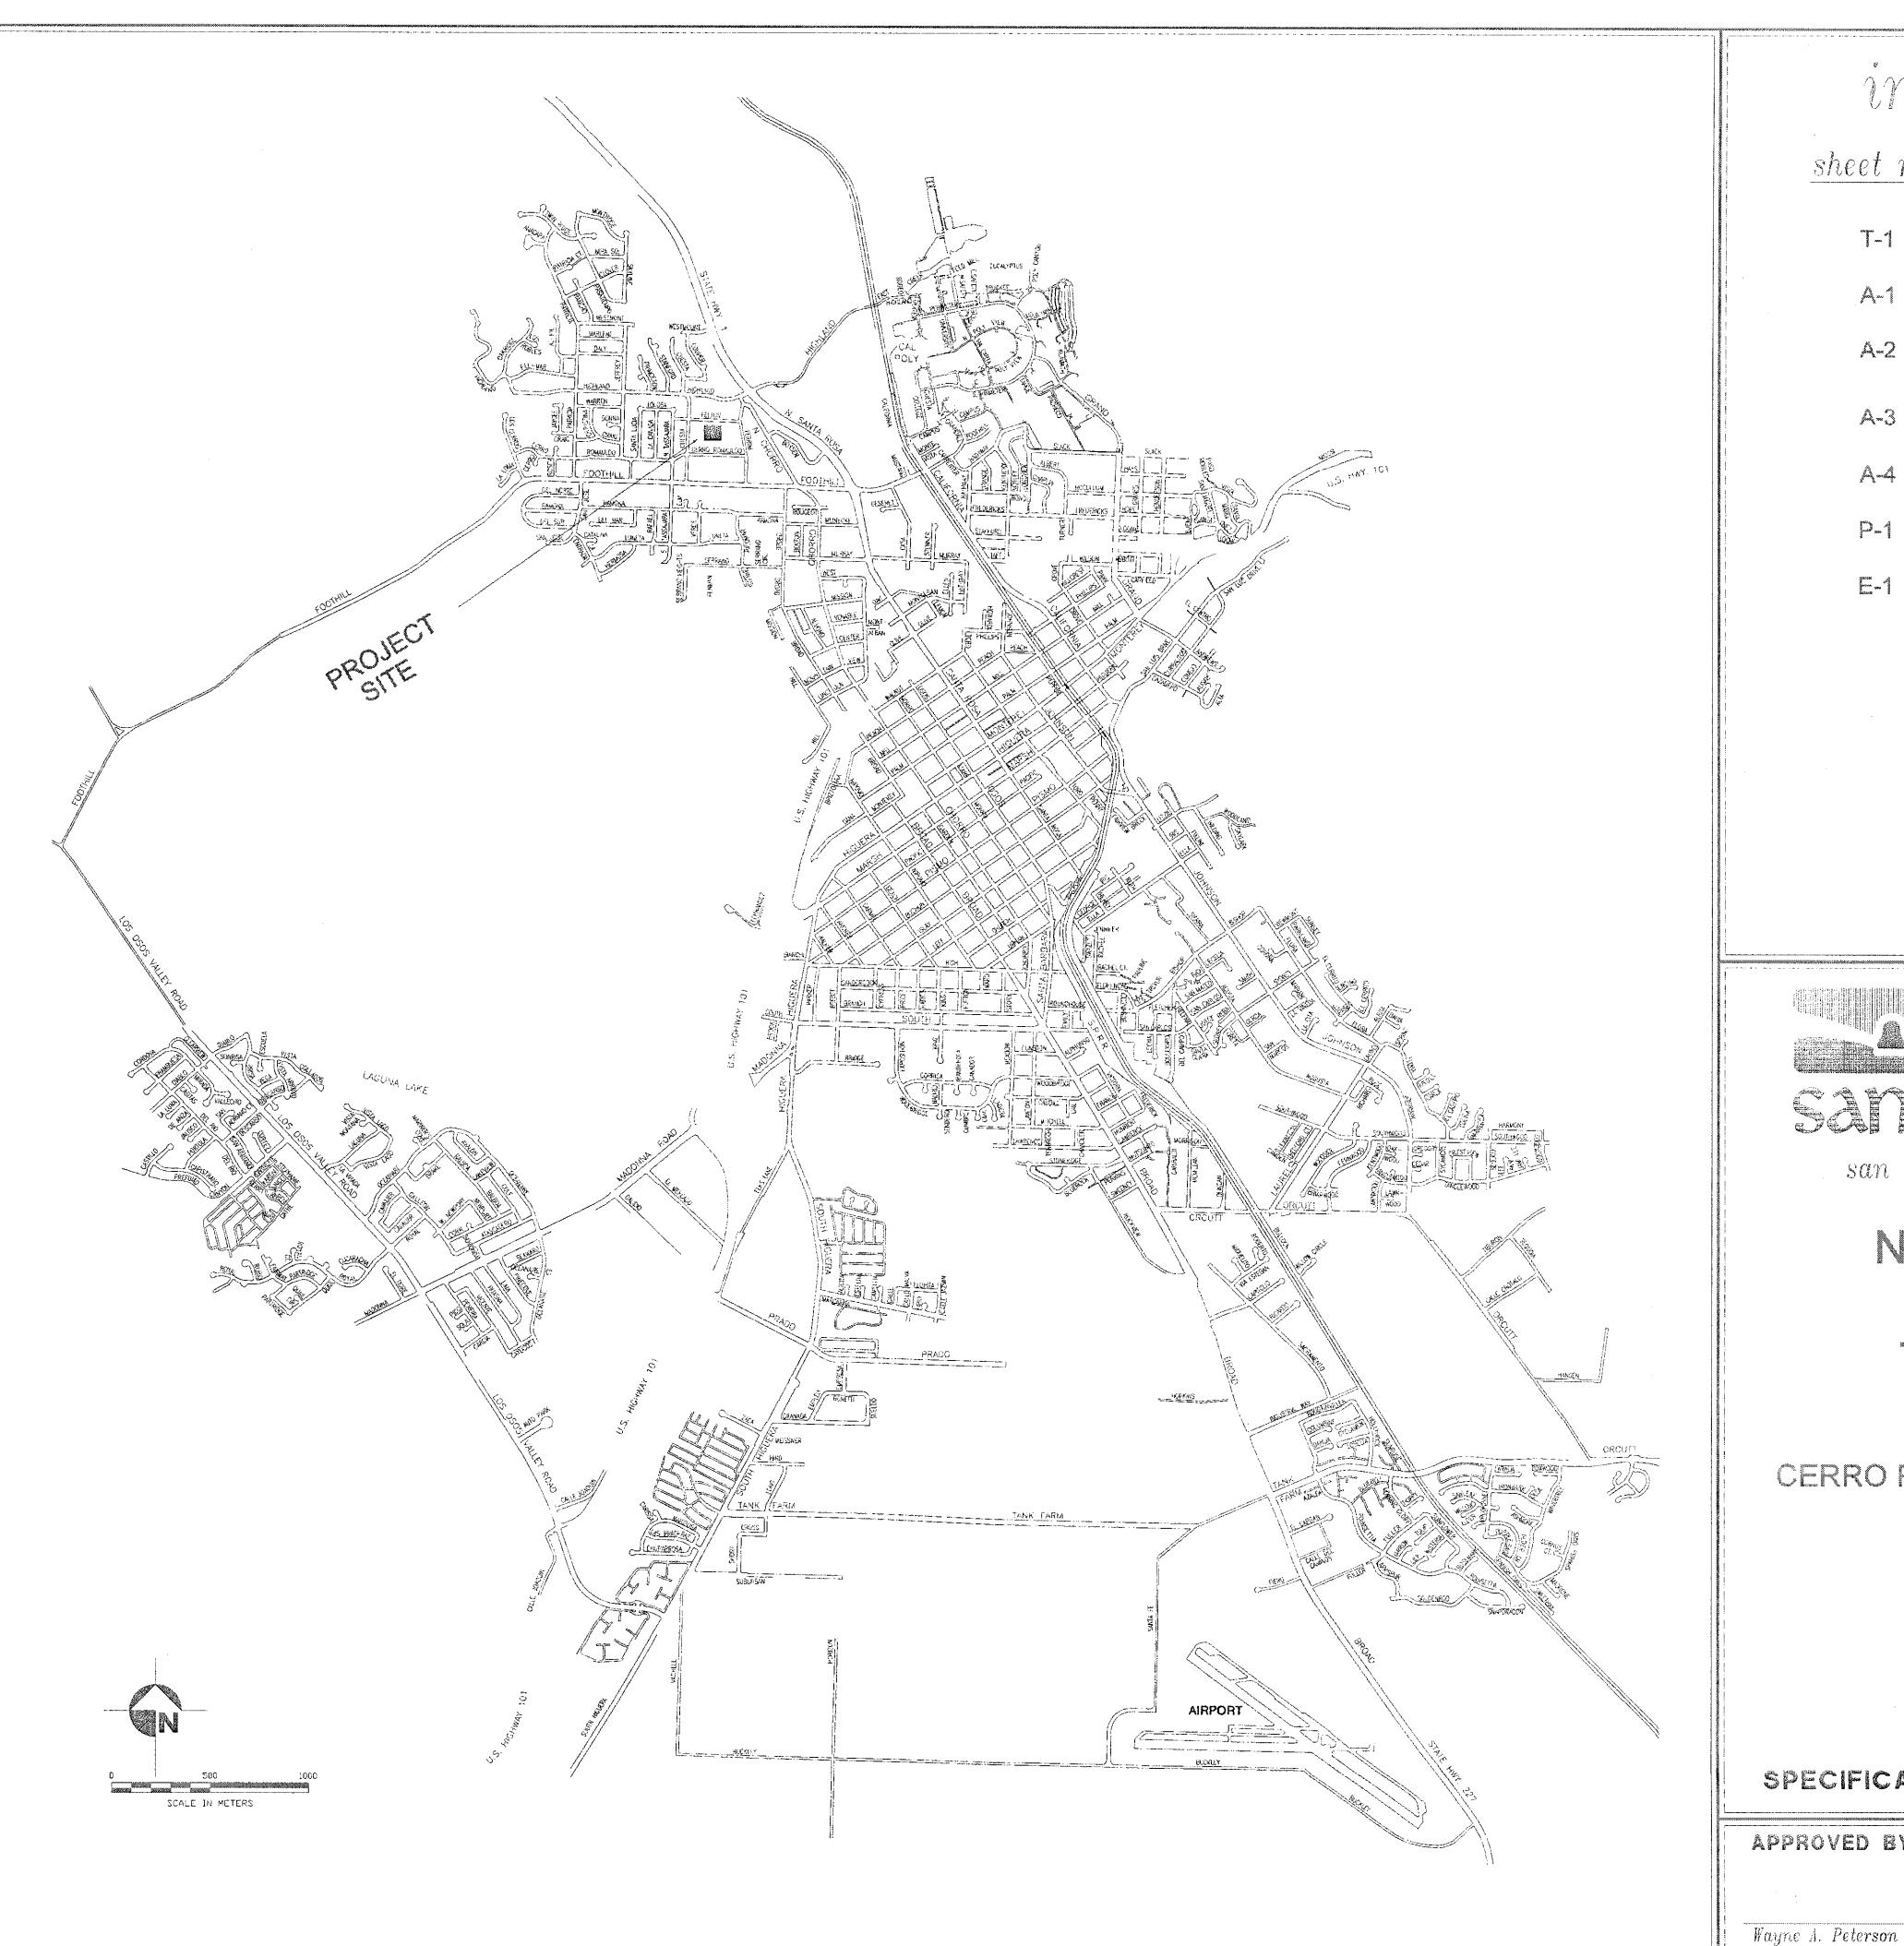

index to plans

sheet no.	$\underline{description}$
and the second s	TITLE, COVER SHEET
<u> </u>	SITE PLAN
A-2	FLOOR PLAN, EXTERIOR ELEVATIONS
A- 3	STRUCTURAL PLANS, SECTIO
A-4	DETAILS
P. 4	PLUMBING PLAN, NOTES
gentee g gentee gentee gentee gentee gentee gentee gentee gentee g gentee g gentee g g gentee g g g	ELECTRICAL PLAN, NOTES

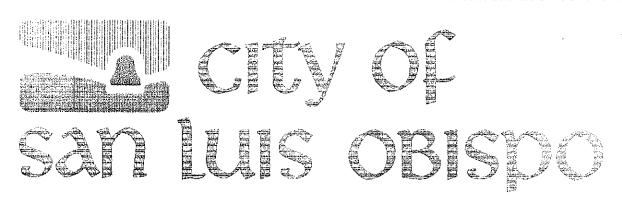

san luis obispo county, california

NEW RESTROOM THROOP PARK

CERRO ROMAULDO AT CUESTA DRIVE SAN LUIS OBISPO, CA

RECORD DRAWING
DATE: __06/07/02 BY: __SR


Specification No. 99828


APPROVED BY

City Engineer

0085 B

R.C.E. 18598 R

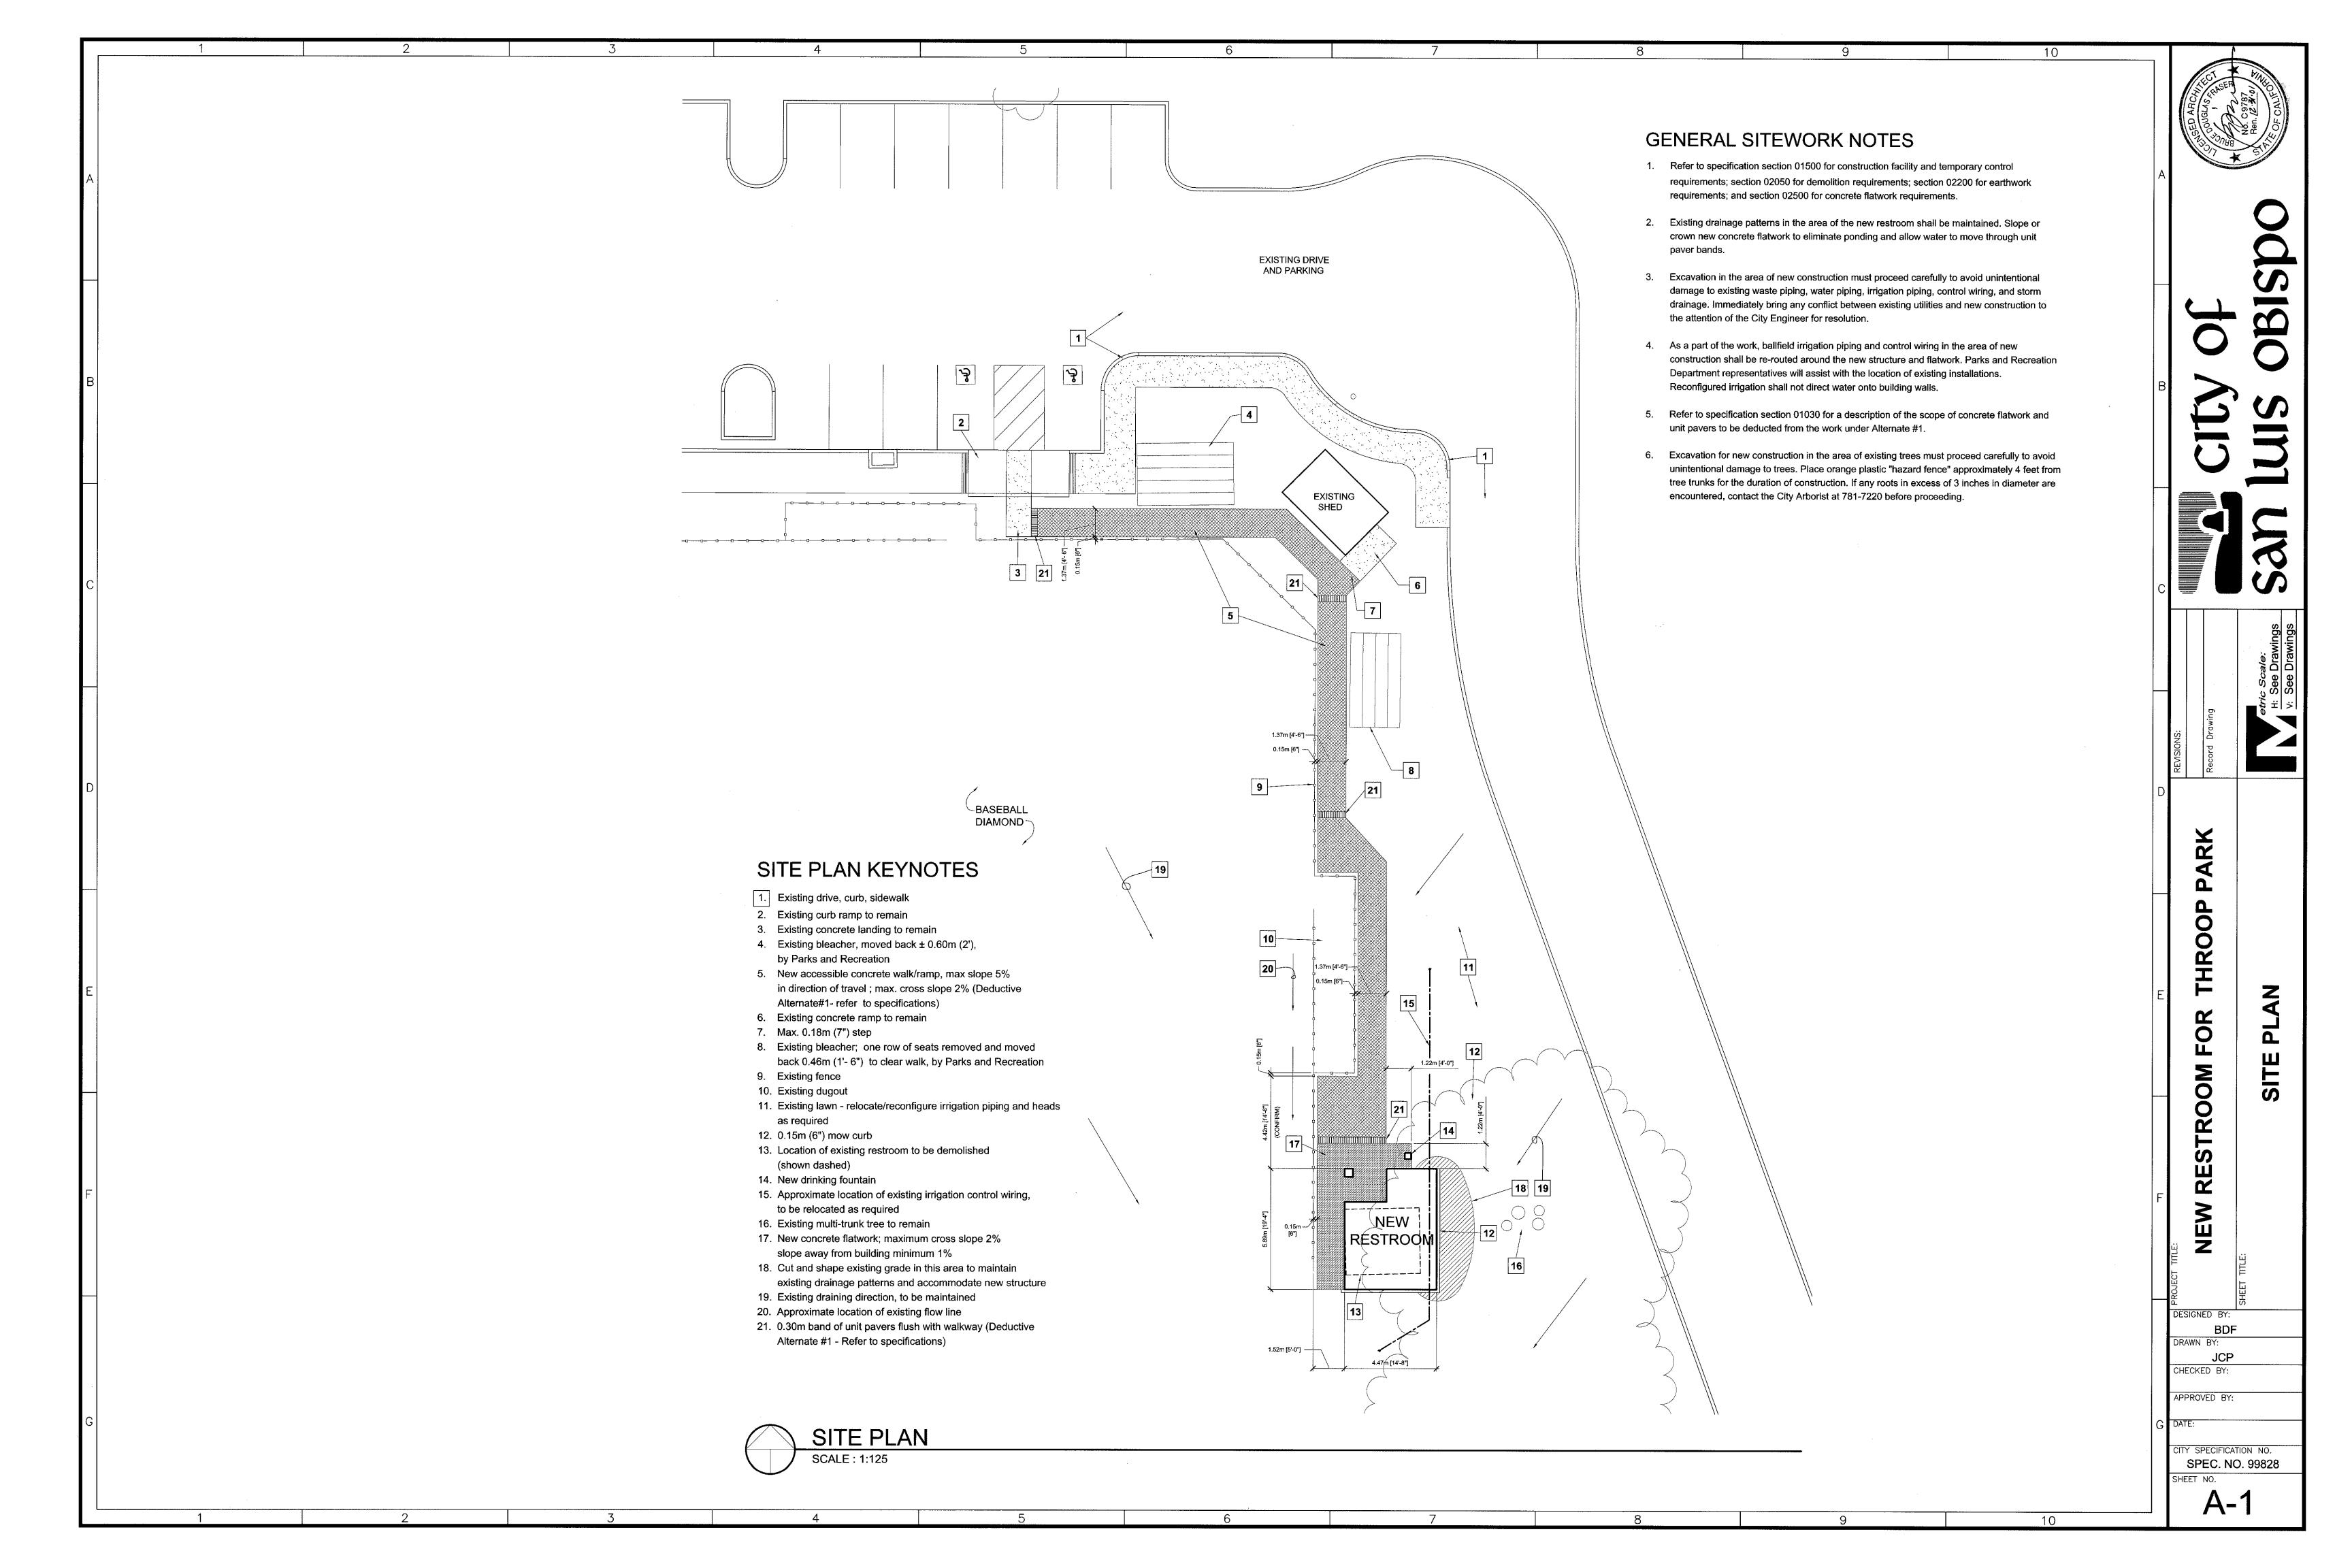

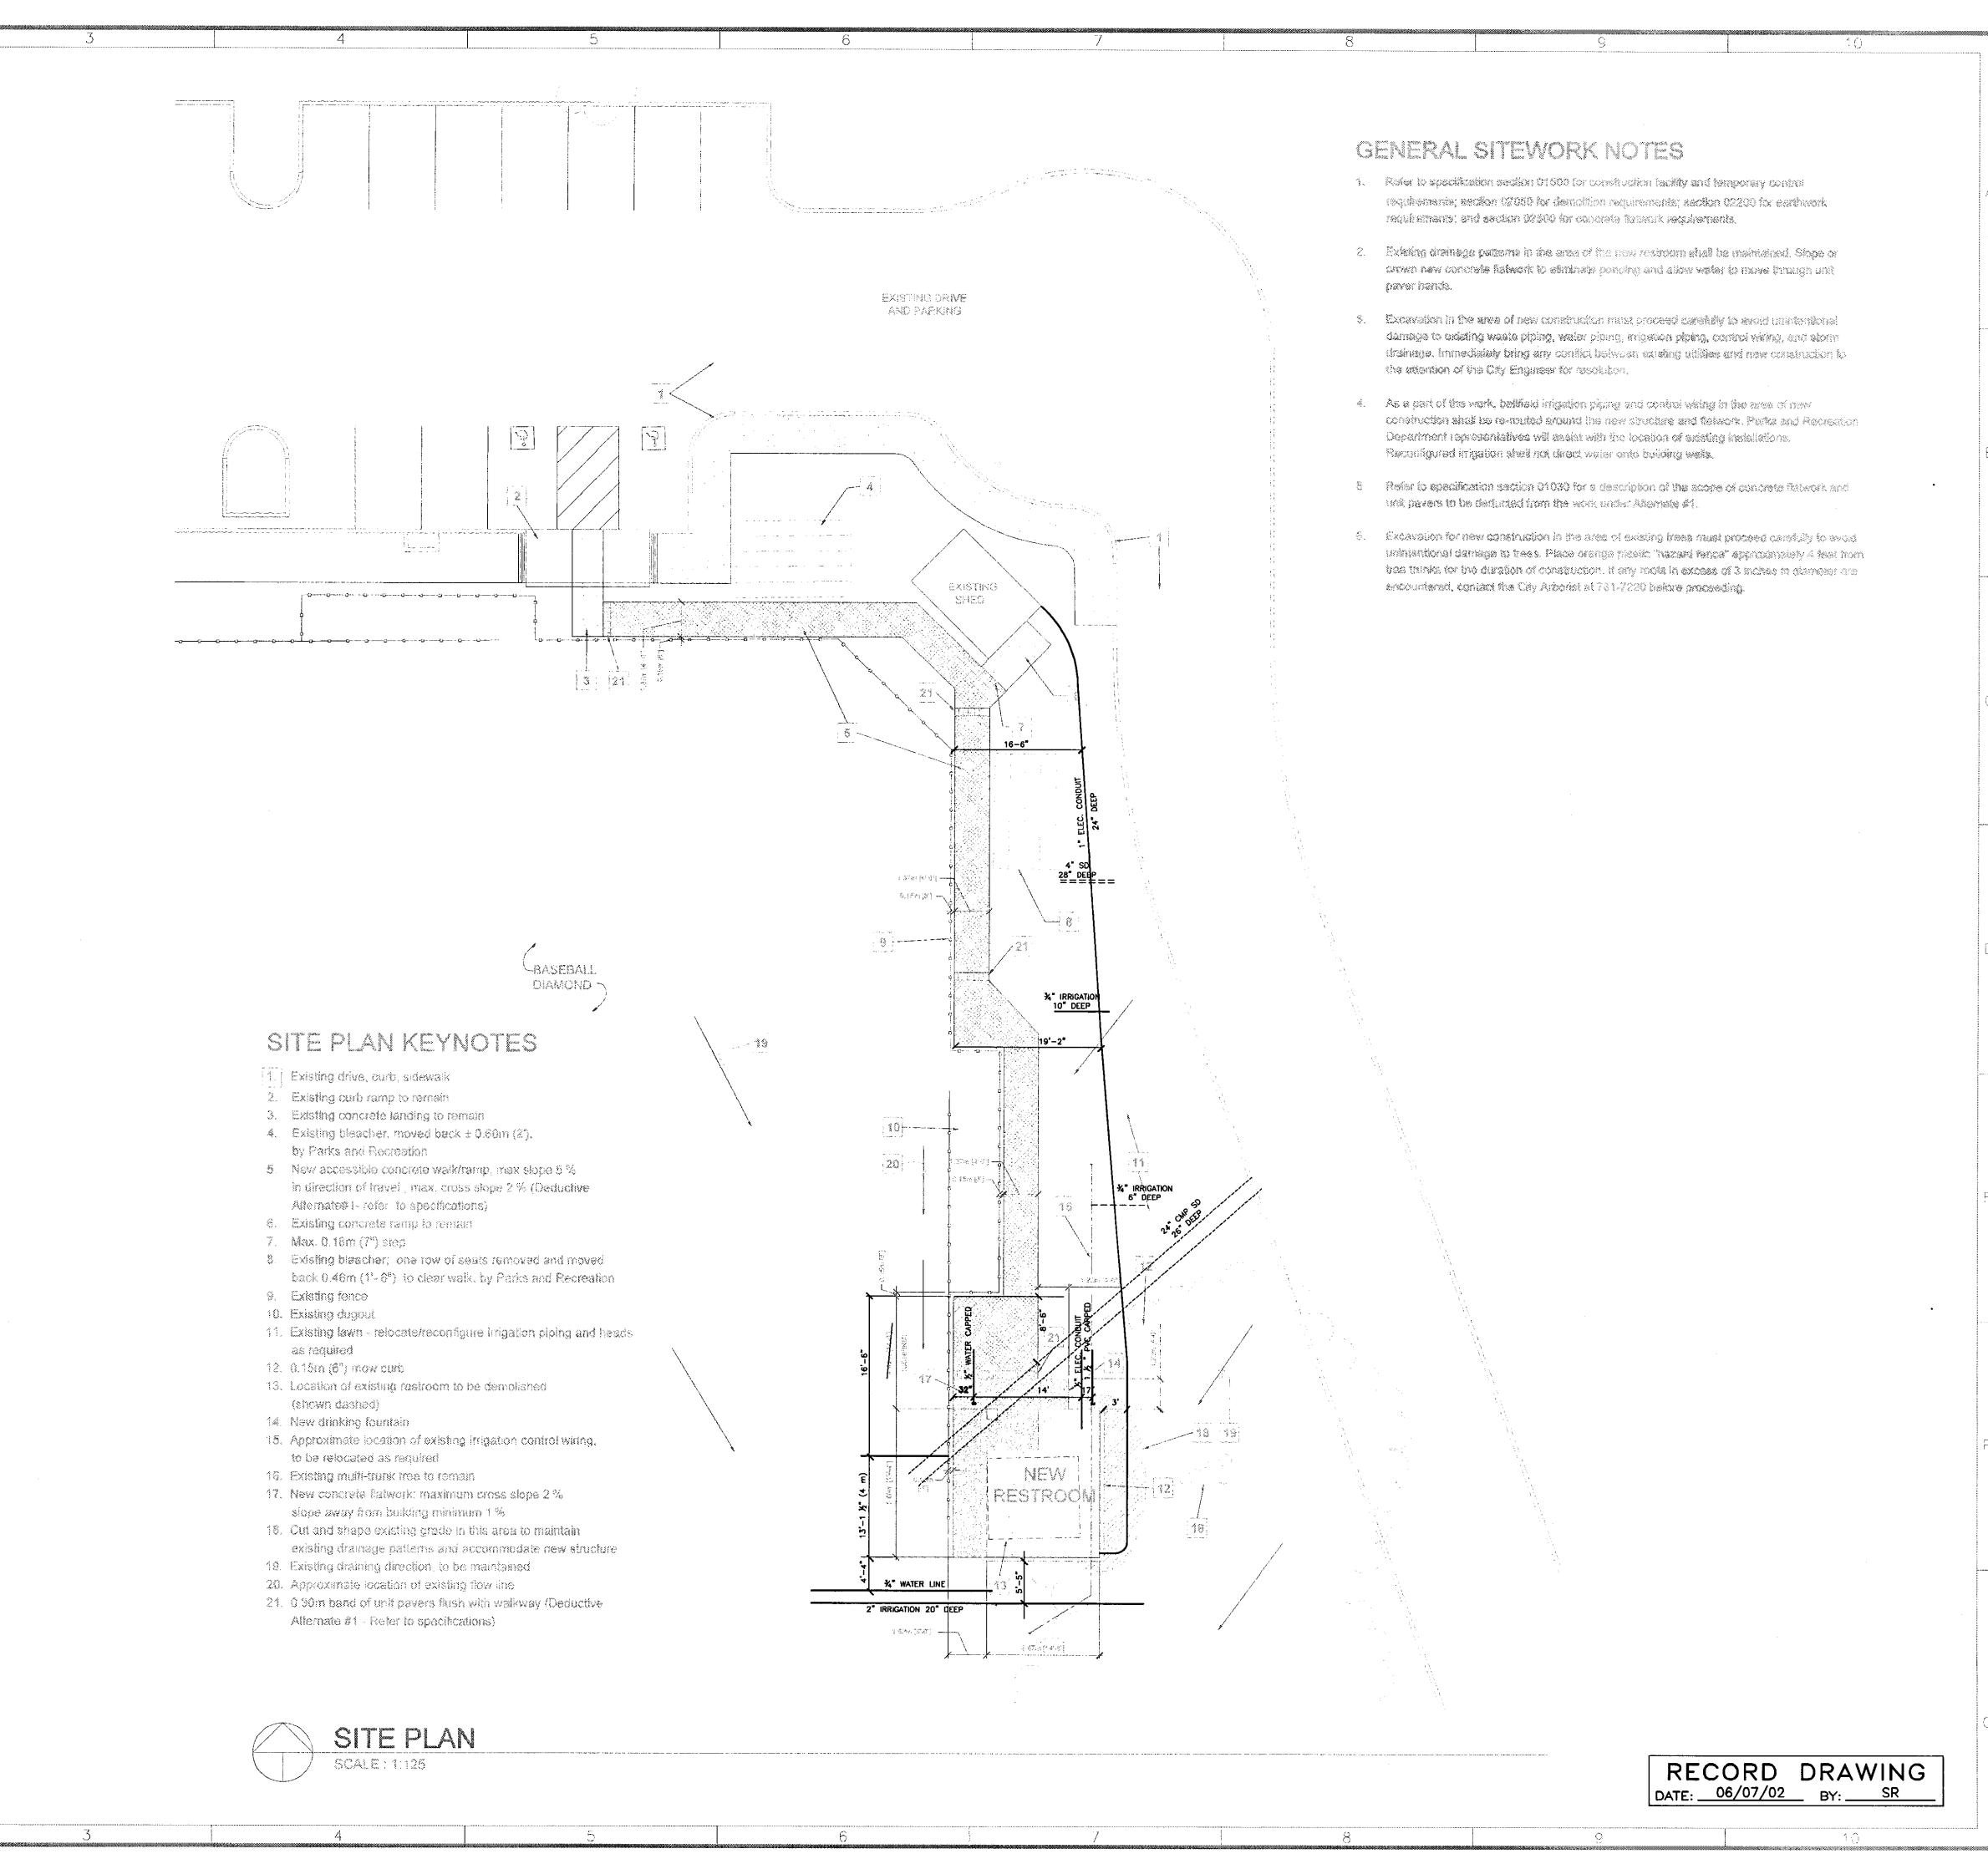


es lead

BDF

JCP

SPEC. NO. 99828


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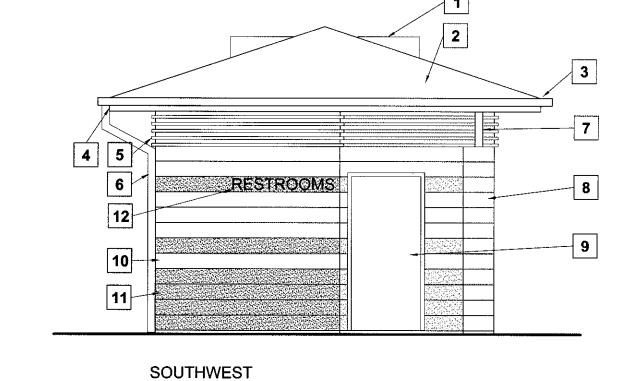


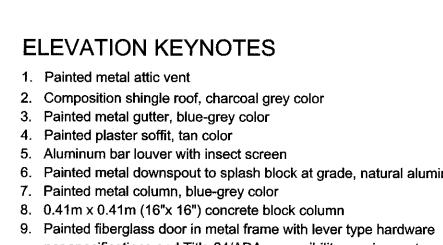
12. 6 inch plastic dimensional letters, black


6. Painted metal downspout to splash block at grade, natural aluminum finish 7. Painted metal column, blue-grey color 8. 0.41m x 0.41m (16"x 16") concrete block column

per specifications and Title 24/ADA accessibility requirements 10. Pigmented "precision" 0.21m (8 inch) concrete block, "Nutan" color 11. Pigmented "ground face" 0.21m (8 inch) concrete block, "Sangria" red color



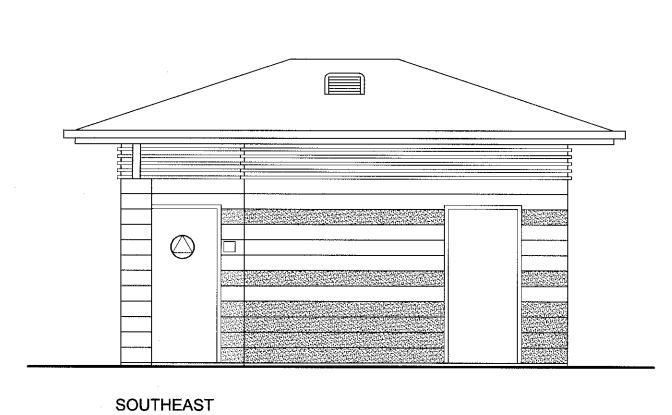

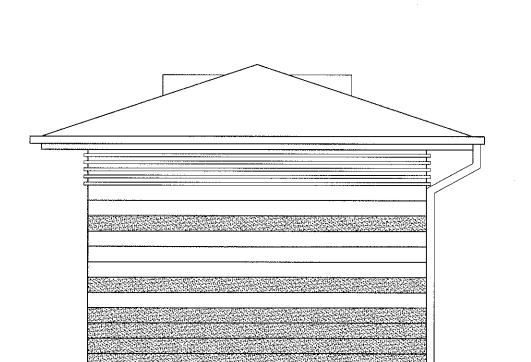

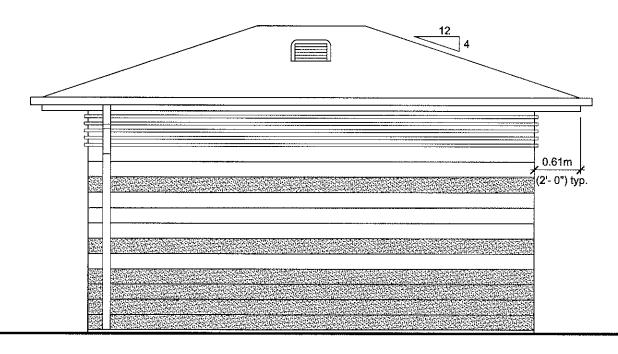



NORTHEAST


NORTHWEST

EXTERIOR ELEVATIONS

SCALE : 1:50

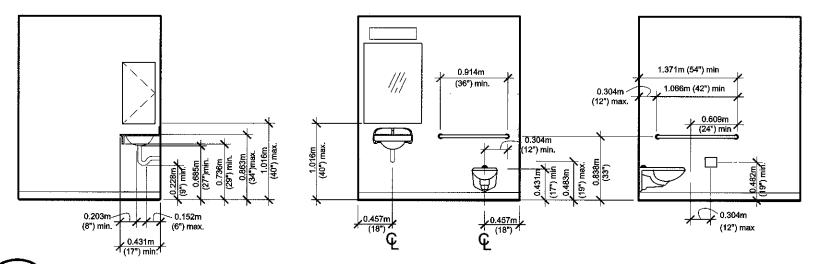

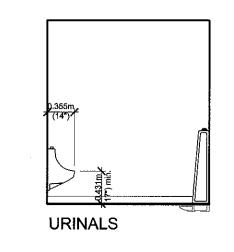

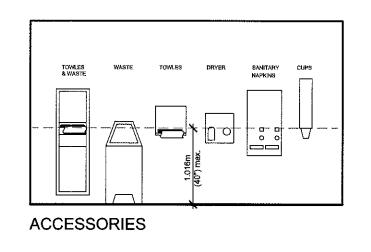


MOUNTING HEIGHTS
SCALE: 1:50

D108002A

FLOOR PLAN KEYNOTES

- 1. Line of overhang above
- 2. Concrete block column
- 3. Recessed wall hydrant
- 4. Wall-hung water closet
- 5. Wall-hung urinal 6. Wall-hung lavatory
- 7. Wall-hung baby changing station
- 8. Sealed concrete floor
- 9. Floor drain 10. Electric hand dryer
- 11. Grab bars
- 12. 0.91m x 2.03m (3'- 0"x 6'- 8") fiberglass door
- in metal frame
- 13. Wall surface-mounted toilet paper holder
- 14. Accessibility signage per Detail 50, Sheet A-4

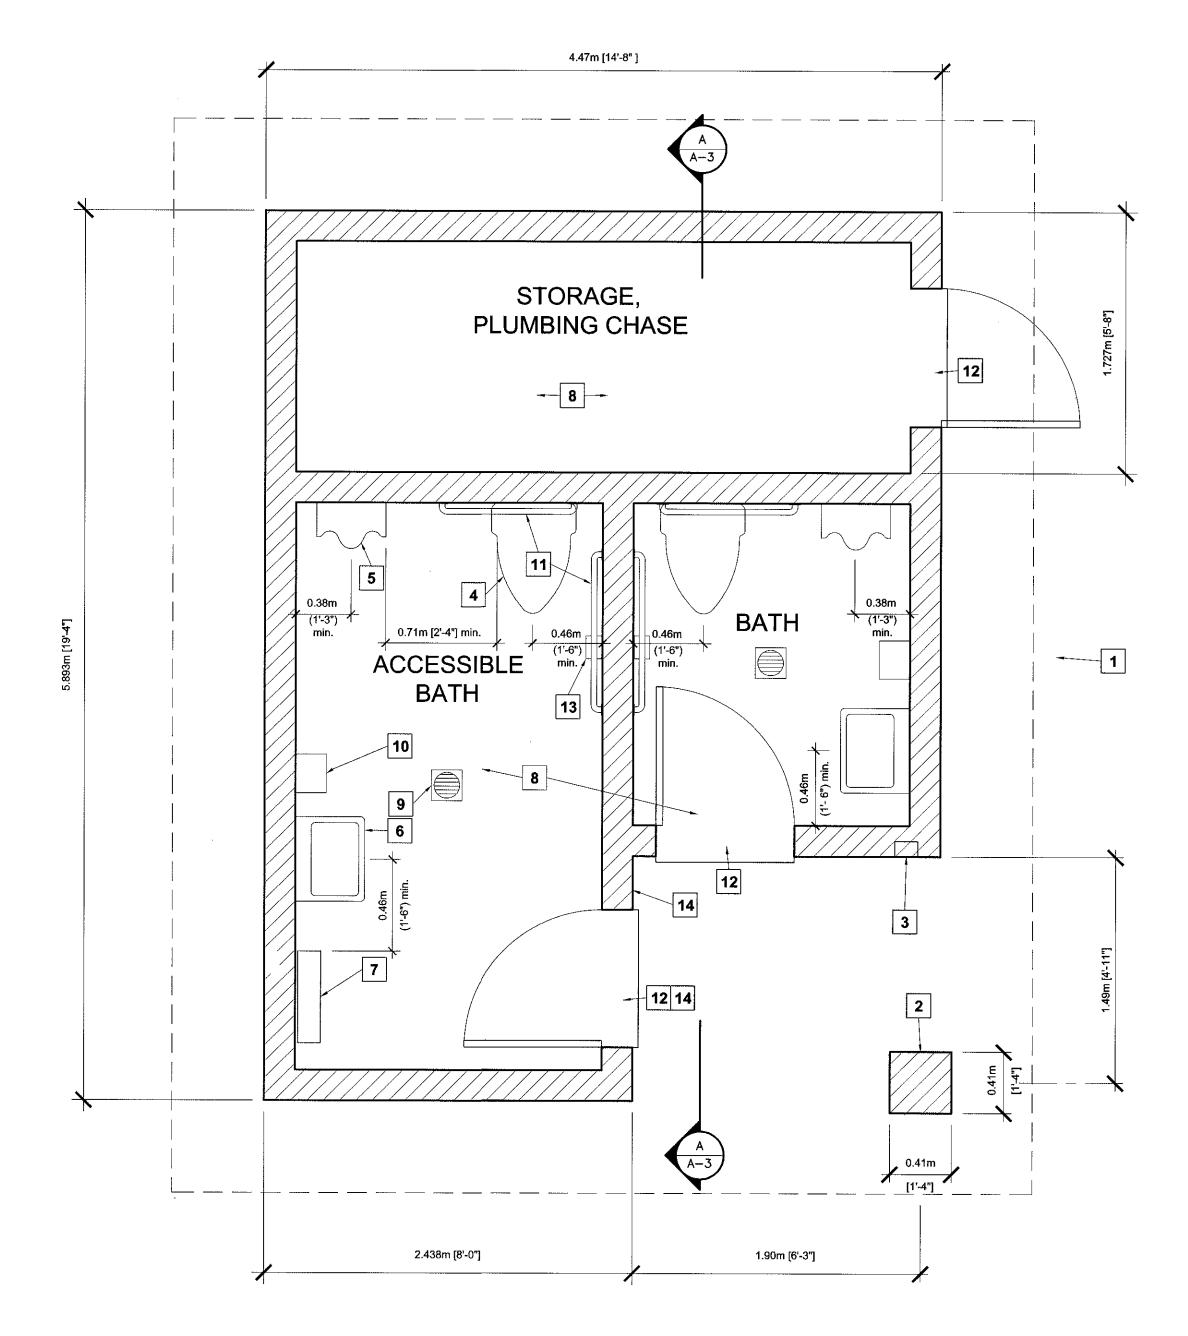



FLOOR PLAN

10

PARK

ELEVATIONS THROOP FOR RESTROOM


DESIGNED BY:

NEW

APPROVED BY:

SPEC. NO. 99828


10

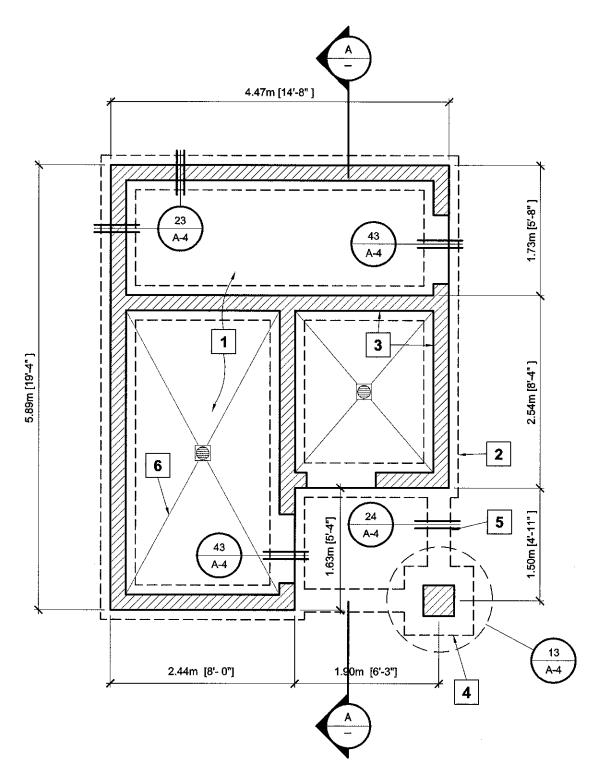

FOUNDATION PLAN KEYNOTES

- 1. 0.10m (4") Concrete slab with #4 bars @ 0.61m (24") o.c. each way at mid-depth of slab over 0.10m (4") compacted sand base with waterproof membrane at mid-depth of sand
- 2. Concrete footing
- 3. Concrete block walls
- 4. Column pad footing
- 5. Concrete tie beam 6. Slope slab to drains as indicated



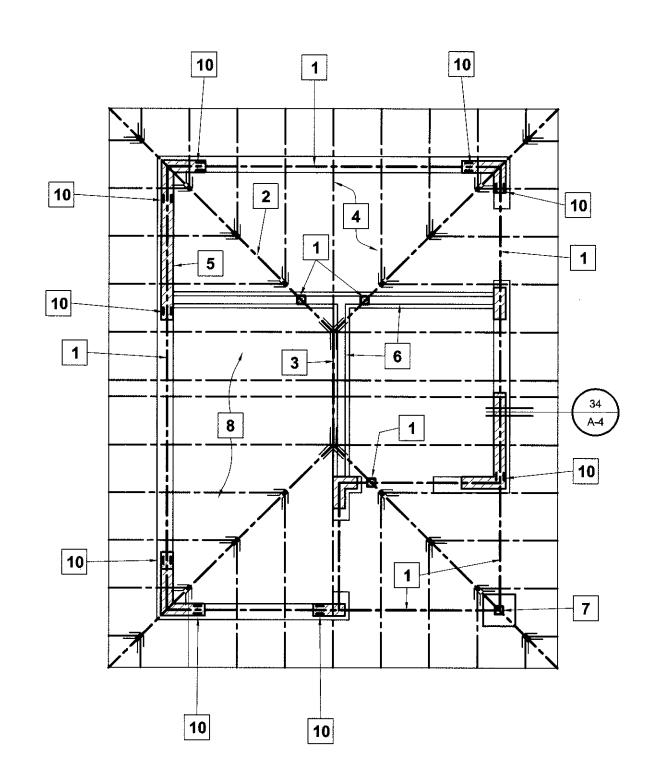


FRAMING PLAN KEYNOTES

- 1. 4X10 Header/Beam, typical
- 2. 2X10 Ridge, typical 3. 2x10 Ridge board
- 4. 2x6 Rafters @ 0.61m (24") o.c.
- 5. 6" Conc. block partial walls
- A. Solid grout
- B. #4 vert at 16" o.c. 6. 2x4 Wood stud cripple walls
- A. 2x4 #2DF at 16" o.c.



ROOF FRAMING PLAN

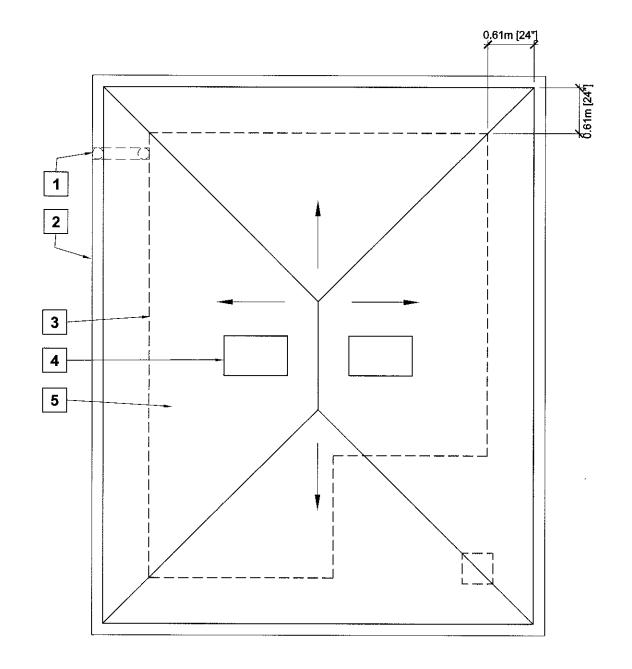


ROOF PLAN KEYNOTES

- 1. Metal downspout to splash block at grade
- 2. Continuous metal gutter
- 3. Line of wall below 4. Metal dormer vent
- 5. Compisition shingle roof (4:12 slope)



ROOF PLAN


SCALE: 1:50

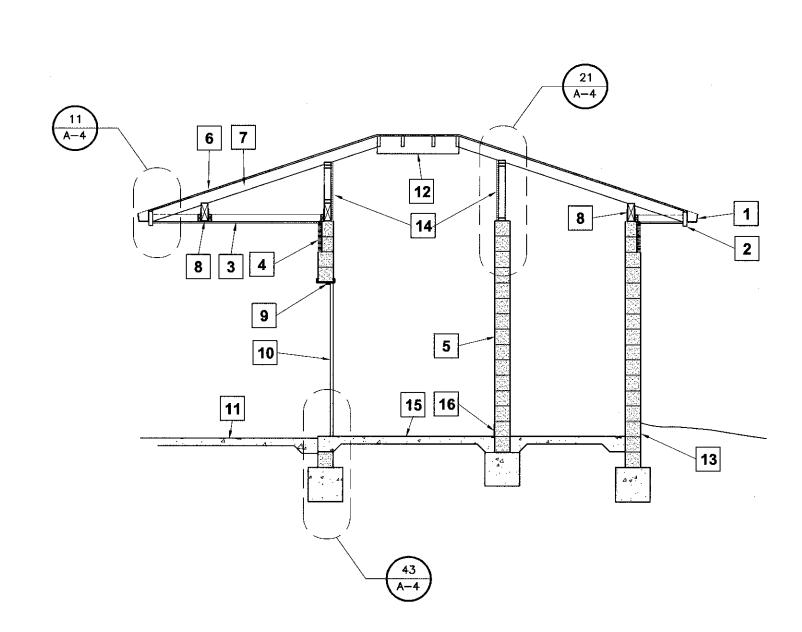

BUILDING SECTION
SCALE: 1:50

SECTION KEYNOTES

- 1. Metal rain gutter, prefinished
- 2. Wood fascia, painted 3. Plaster soffit, painted
- 4. Continuous aluminum vent.
- 5. Concrete block wall, painted at interior 6. Composition asphalt shingles
- 2x wood framing
- 8. 4x10 header/beam continuous around building exterior
- Hollow metal door frame
- 10. Fiberglass flush panel door, painted 11. Concrete walk/landing
- 12. Exposed framing and sheathing, painted
- 13. Waterproof wall below grade 14. Perforated metal screen, painted (cement board and
- plaster, painted, at wall between bathrooms)
- 15. Concrete slab, slope to drain
- 16. Tile wall base

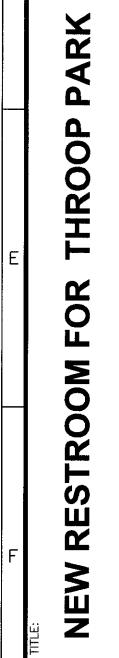

ANS

-OUNDATION SECTION


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DRAWN BY:

CHECKED BY: APPROVED BY:

CITY SPECIFICATION NO. SPEC. NO. 99828 SHEET NO.

A-3

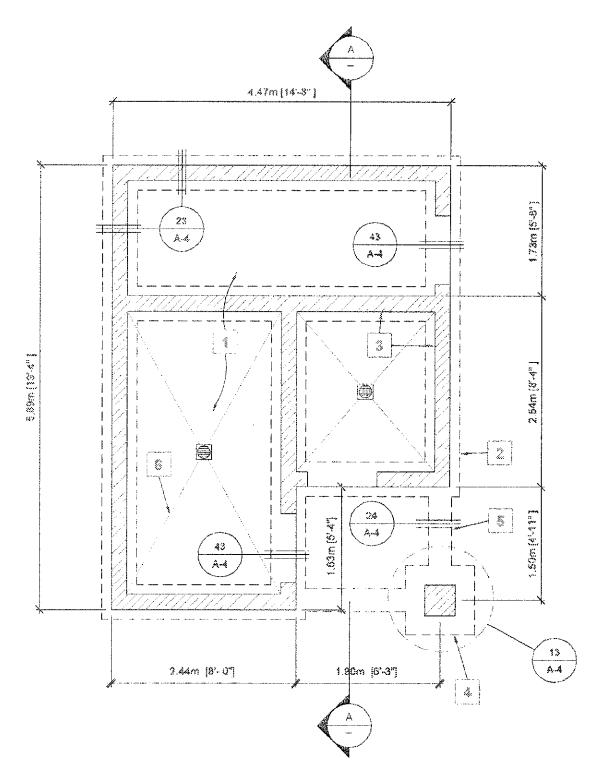


FOUNDATION PLAN KEYNOTES

- 0.10m (4") Concrete slab with #4 bars (§ 0.61m (24") o.c. each way at mid-depth of slab over 0.10m (4") compacted send
- base with waterproof membrane at mid-depth of sand

 2. Concrete footing
- Concrete block walls
- Column pad footing
 Concrete ite beam
- 6. Stope slab to drains as indicated



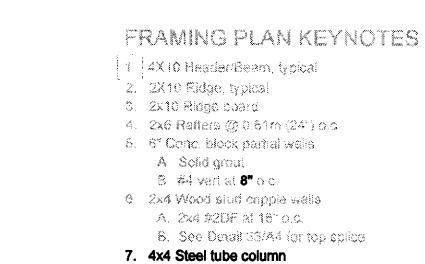

A. See Detail 22/A4

8. 1/2" Plywood roof sheathing, Span rating 24/0


A. 8d @ 6-6-12"o.c.

B. Stagger sheets
 C. Lay with face grain perpendicular to framing


101


9. 4x4 #1 DF king post 10. Simpson EPC44 A. See Detail 34/A4



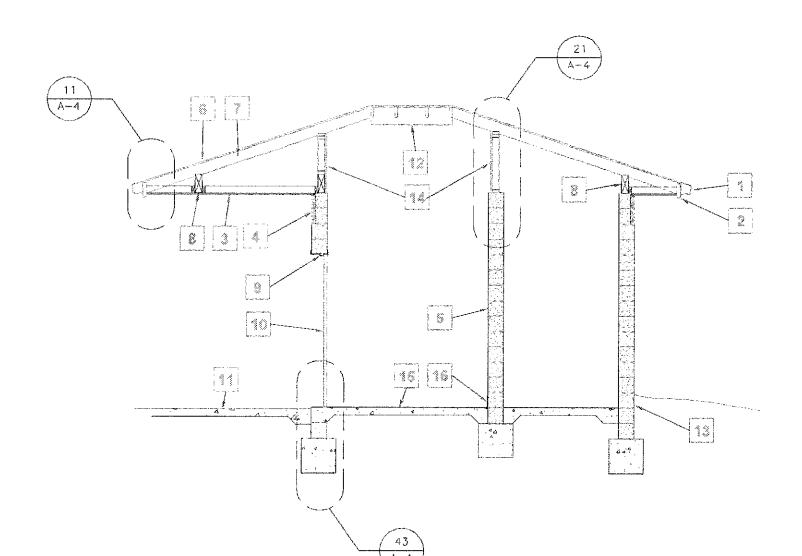

BUILDING SECTION

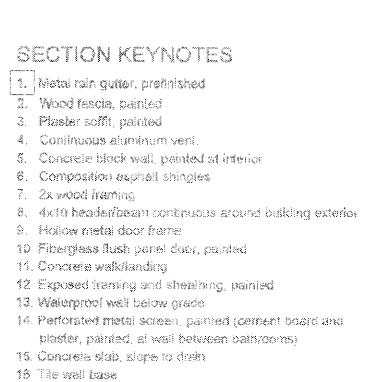

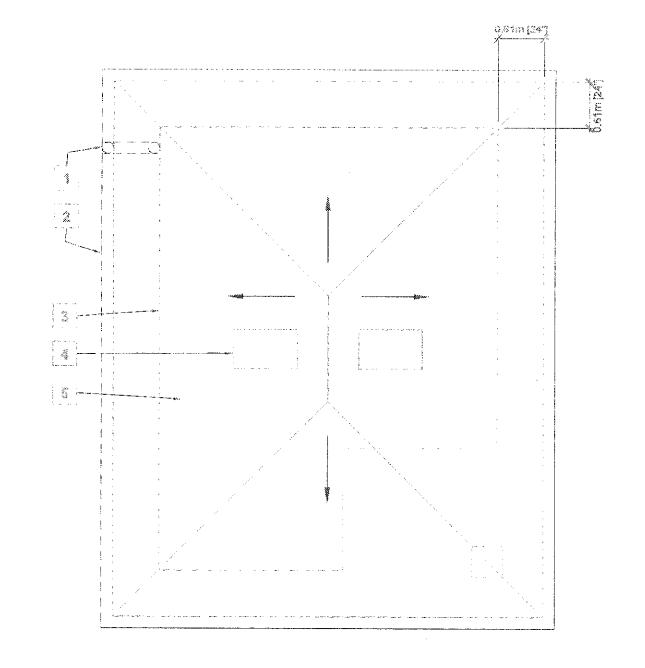

ROOF PLAN KEYNOTES

1. Mirial downspoul to splach block at grade

2. Continuous metal gutter
3. Line of wall below

A. Matal donner vant

8. Compisition shingle roof (4:12 slope)



RECORD DRAWING
DATE: 06/07/02 BY: SR


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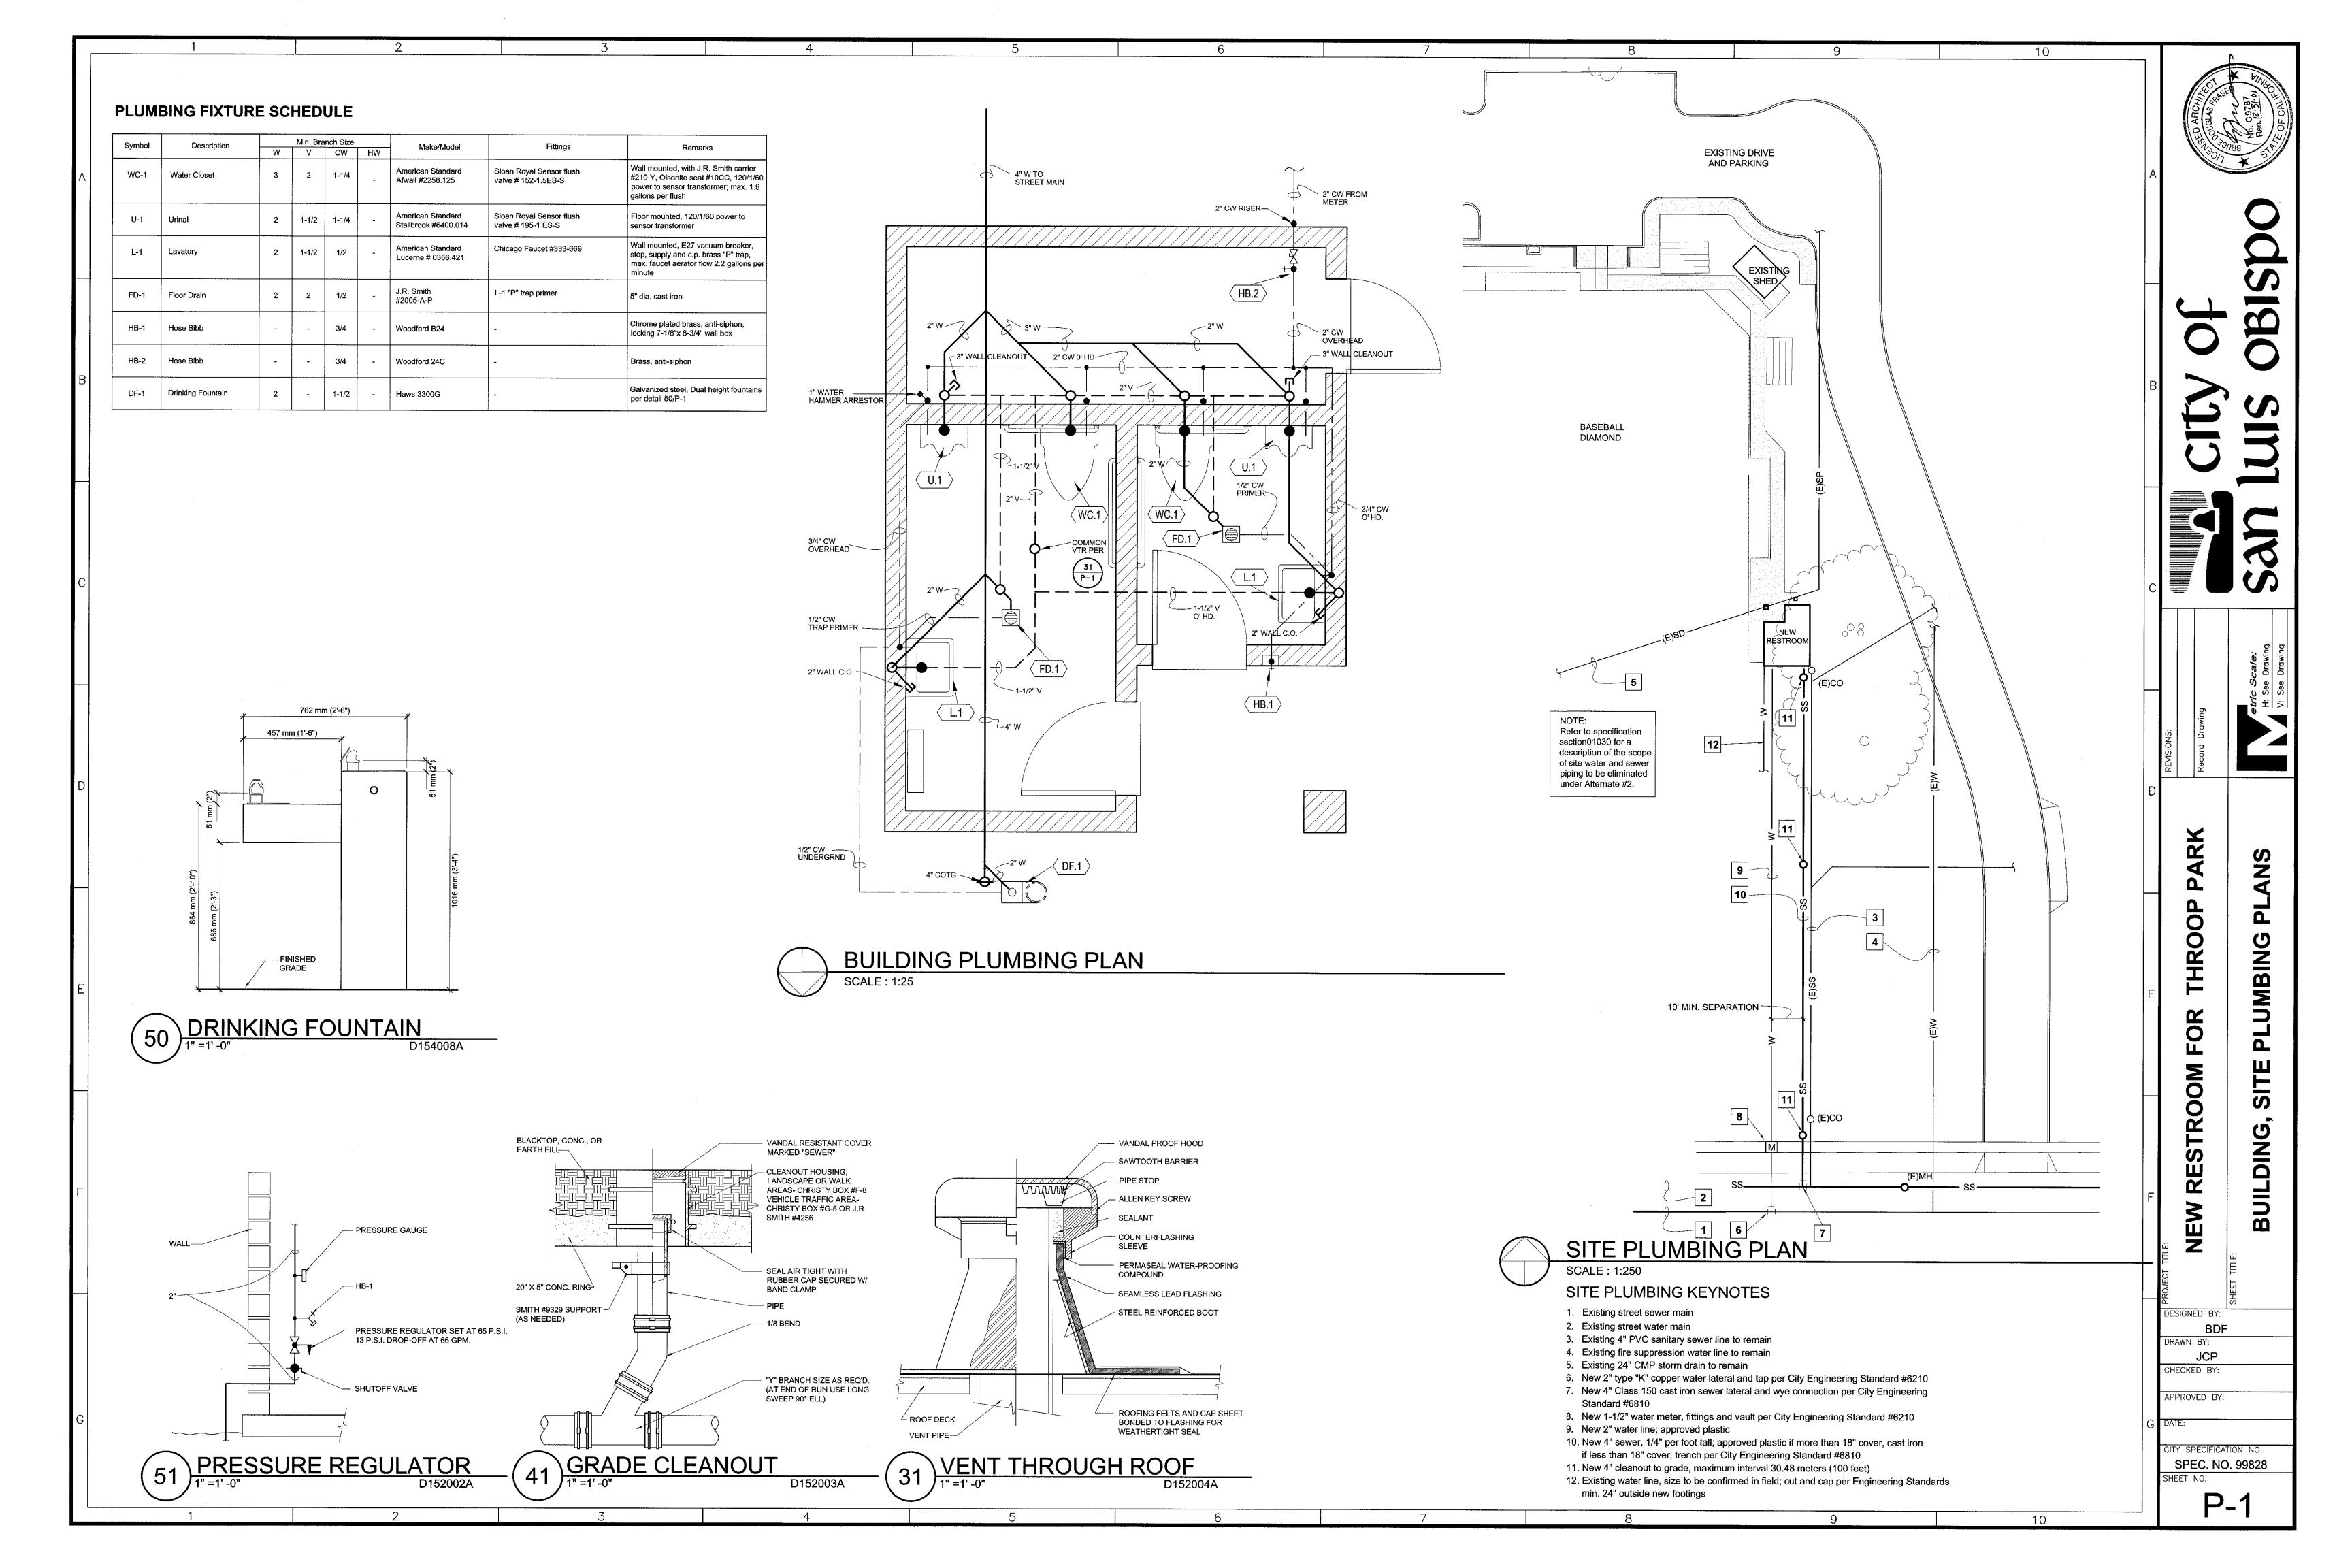
A-3 R


SPEC. NO. 99828

BDF

JCP



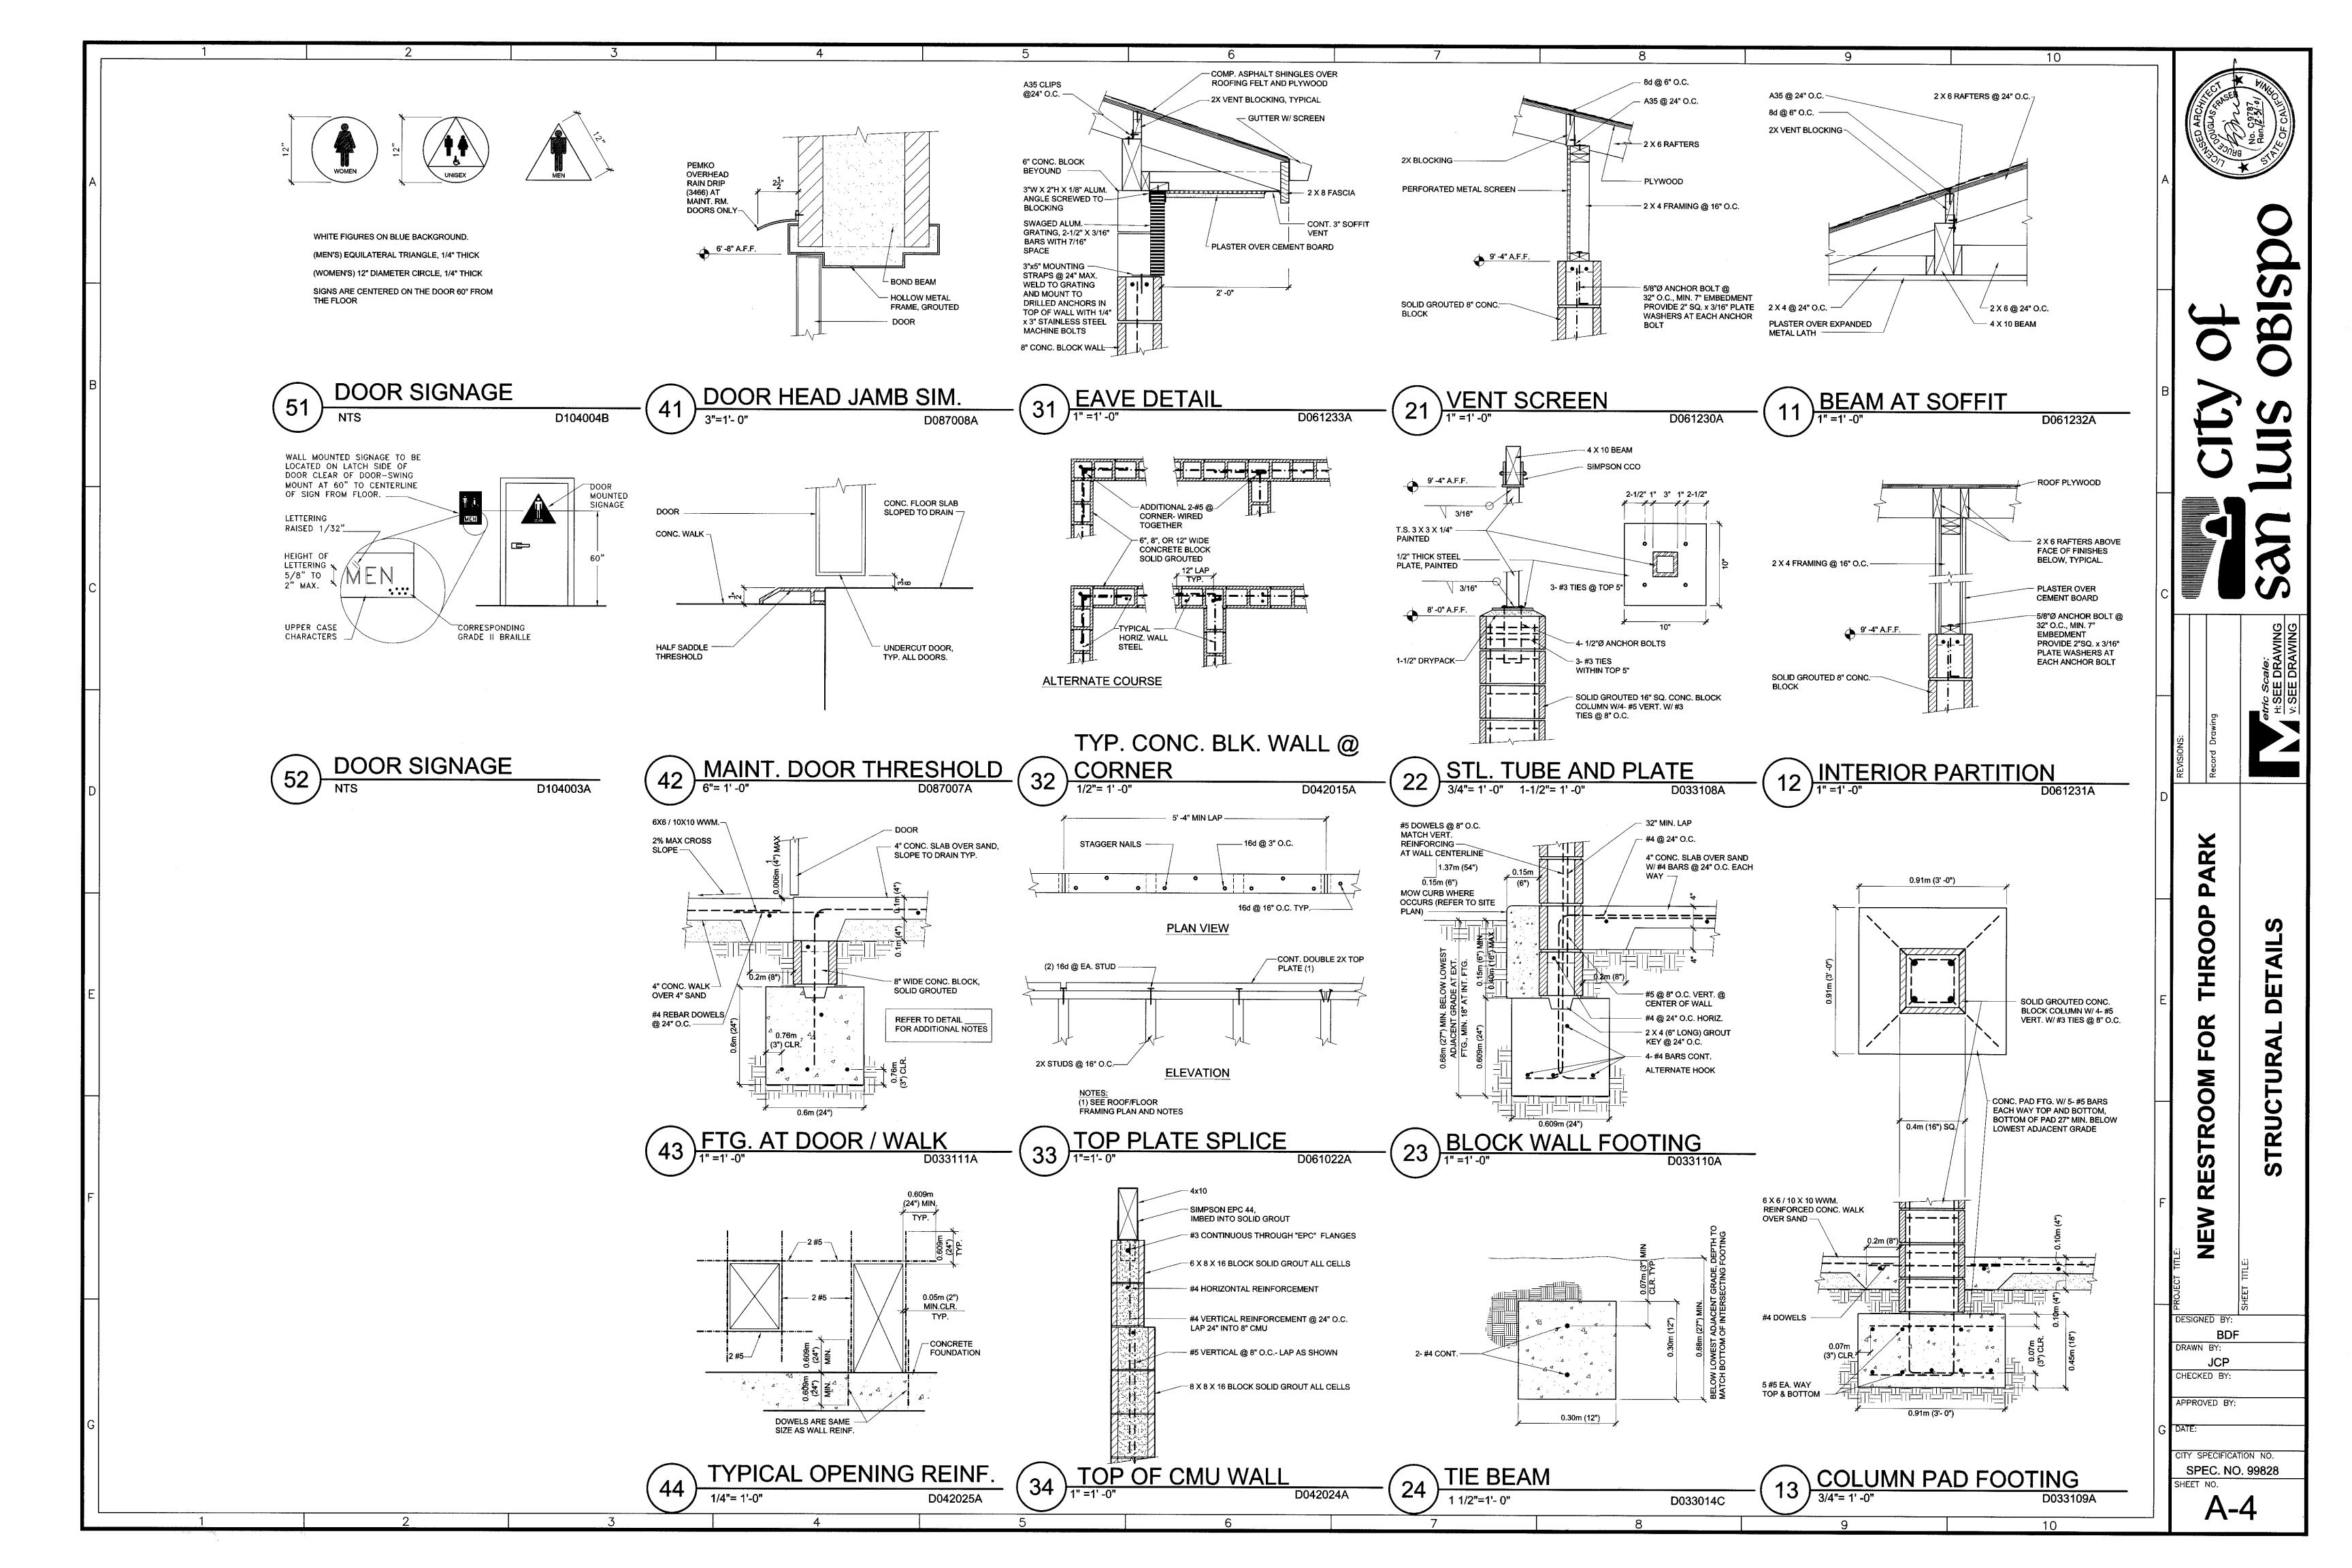

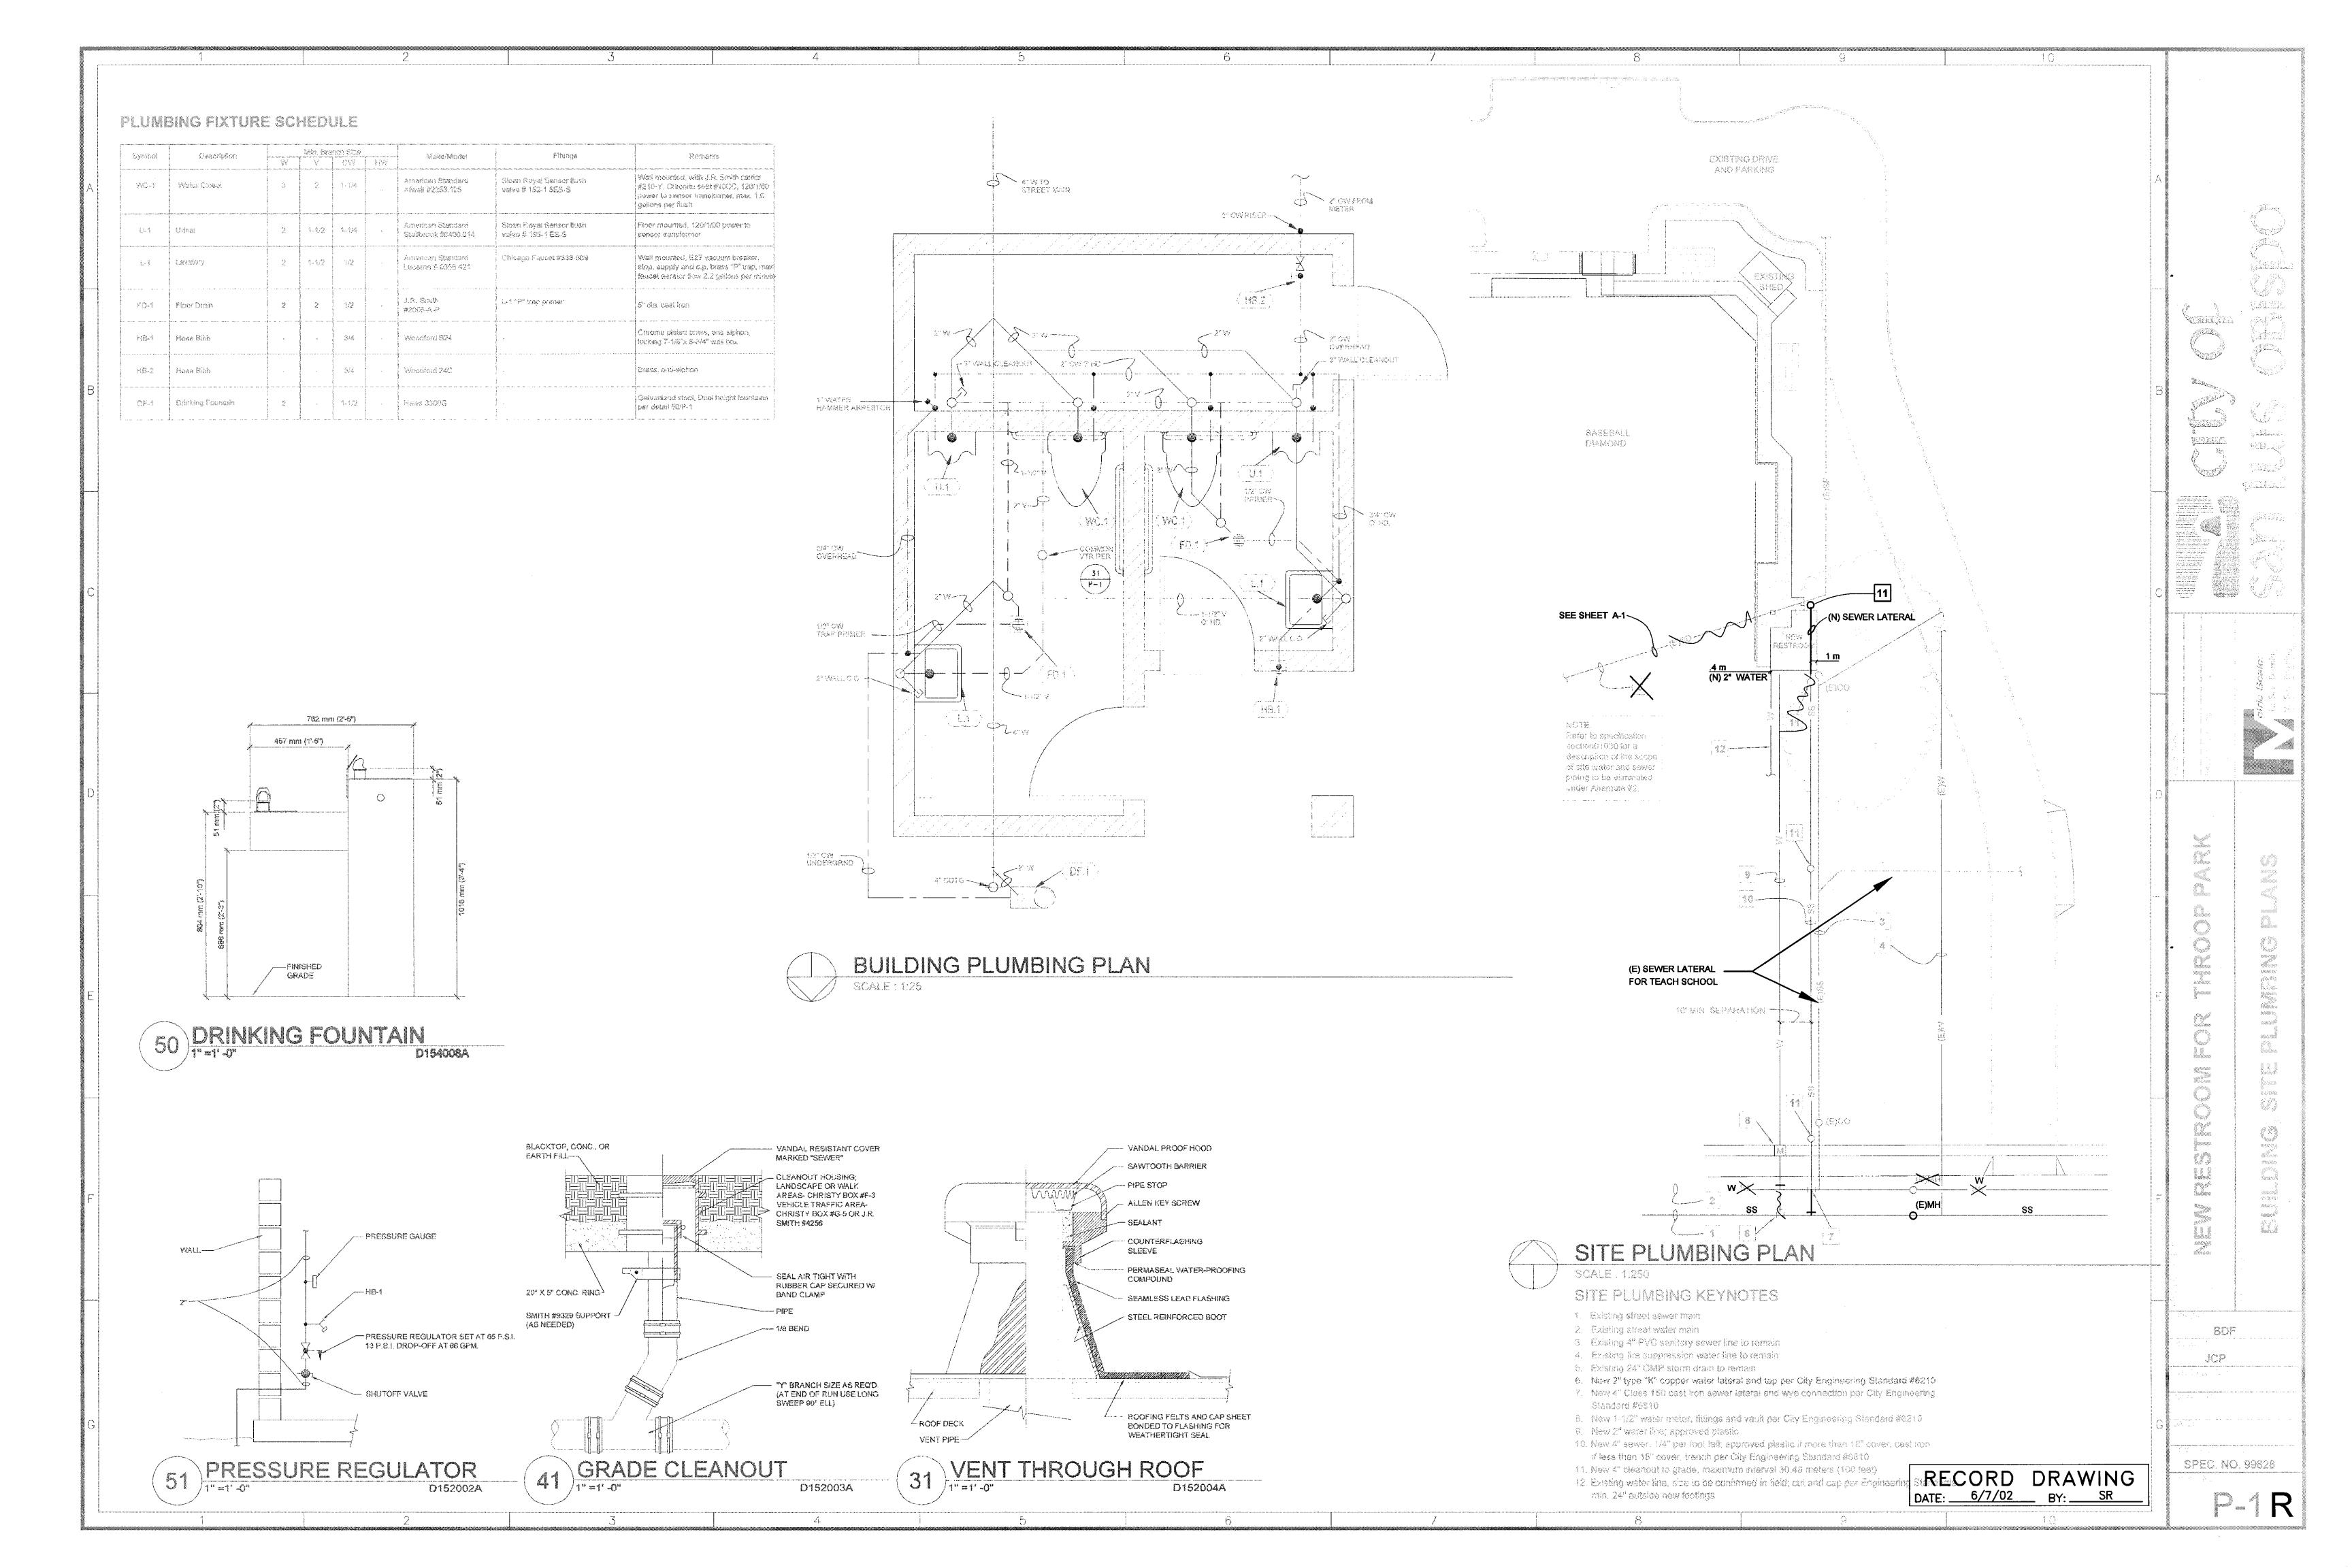

GENERAL NOTES

- 1. CODE COMPLIANCE: All work shall conform to and be performed in accordance with codes, standards, and ordinances as set forth by the authorities having jurisdiction and their latest adopted editions (in effect at time of building permit application) of the following publications:
- (a) California Code of Regulations Title 24; includes 1995 California Electrical Code, Uniform Fire Code, Uniform Building Code, etc. with California and other local amendments as applicable. (b) Americans with Disabilities Act (ADA)
- 2. SAFETY: The Electrical Contractor is responsible to maintain all equipment in a safe and responsible manner. Keep dead front equipment in place while equipment is energized. Conduct all construction operations in a safe manner for employees as well as other workpersons or anyone visiting the job site. Provide barriers, flags, tape, etc. as required for safety. The Contractor shall hold all parties harmless of negligent safety practices which may cause injury to others on or near
- 3. FIRE RATED ASSEMBLIES shall maintain ratings as specified in 1995 California Building Code chapter 7. General Contractor shall provide and install physical enclosure around fixtures, panels, etc. as required. All assemblies to be penetrated shall be installed with applicable through—penetration firestop system as determined by UL classification. Before construction, verify and comply with requirements of local authority having jurisdiction.
- 4. MOUNTING HEIGHTS in inches to centerline above finish floor shall be as follows unless otherwise
- +16" AFF: receptacles, telephone, TV & data outlets.
- +44" AFF: light switches.
- +48" AFF: fire alarm manual pull stations, T-stats.
- The lower of +80" AFF or 6" below ceiling: fire alarm visuals.
- Before rough—in, verify all mounting heights and exact locations for all equipment electrical connections, stub-ups, receptacles, outlets, etc. with Architect or Owner. Place devices located above counters, shelving, etc. and in bathrooms so as not to conflict with edges of wainscoting, counter splash, shelving, etc. Architectural sheets shall govern.
- 5. LABEL panels, cabinets, backboards, main devices, safety switches, contactors and other specifically designated equipment shown on plans. Use engraved laminated plastic nameplates attached by screws or rivets. Neatly and indelibly label conduit destinations on both visible ends of conduit runs where conduits terminate at designated enclosures, structures or equipment (including pull and splice boxes). Correct existing panel directories and field—labeled designations to reflect new conditions.
- 6. EQUIPMENT GROUNDING CONDUCTORS shall be installed in ALL power system raceways.
- 7. MINIMUM CONDUIT SIZE shall be 1/2" except use minimum 3/4" for underslab homeruns and below grade outside of building exterior walls. Run exposed conduit square and plumb with building
- 8. BEFORE CONSTRUCTION, PROVIDE SUBMITTALS of proposed products for Owner review and approval. All equipment and materials shall be new and listed, labeled or certified for its use by a Nationally Recognized Testing Laboratory (NRTL) as recognized by the US Dept. of Labor, Occupational Safety and Health Administration. The quality and suitability of all products and materials shall conform to the standards and practices of this trade.
- 9. THE ELECTRICAL PLANS indicate the general layout and arrangement; exact locations shall be determined by the architectural drawings and field conditions. Field verify all conditions and modify as required to satisfy design intent. Maintain all required working clearances.
- 10. DISCREPANCIES shall be brought immediately to the attention of the Architect for clarification. Any changes shall be approved by the Architect. Prior to rough—in, refer to architectural plans which shall take precedence over electrical plans with respect to locations.
- 11. PROFESSIONALISM AND APPEARANCE of all installations shall be in accordance with accepted practices of this trade. Installation methods shall conform to manufacturers' specifications. The Contractor shall provide the job with qualified journeymen and helpers in this trade for the duration of the job. It is the Contractor's responsibility to communicate with and keep the job superintendent appraised of changes or clarifications, etc.
- 12. THE INTENT OF THESE SPECIFICATIONS is to establish a standard of quality for materials and equipment. Therefore, some items are identified by manufacturer or trade name designation. Substitutions shall be subject to the Architect's approval. Samples of the proposed and substitute materials may be required for inspection prior to approval. Costs, if any, for evaluation of substitutions shall be the Contractor's responsibility. The decision of the Architect shall be final. Where the substitution will affect other trades, coordinate all changes with those trades concerned and pay any additional costs incurred by them as a result of this substitution. Approval of substitutions shall not relieve the Contractor from providing an operational system in accordance with all applicable codes and ordinances.
- 13. STORAGE OF EQUIPMENT for the job is the responsibility of the Electrical Contractor and shall be scheduled for delivery to the site as the equipment is required. Damage to the equipment delivered to the site or in transport to the job shall be the responsibility of the Electrical
- 14. USE STEEL OUTLET BOXES only.
- 15. SWITCHES AND RECEPTACLES shall be 20 amp.
- 16. ALL POWER SYSTEM CONDUCTORS shall be copper with type THHN/THWN insulation,
- INSTALLED IN ALL RACEWAYS.
- 17. PROVIDE NEAT AND ACCURATE FIELD RECORD DRAWINGS to Owner upon completion of work.
- 18. GUARANTEES: All equipment and labor shall be guaranteed and warranted free of defects, unless otherwise stated to be more restrictive, for a period of one year from the date of final acceptance by the Owner. A written warranty shall be presented to the Architect at the time of completion prior to final acceptance. Equipment deemed to be damaged, broken or failed shall be repaired or replaced at no additional cost to the Owner.
- 19. THE FOLLOWING RACEWAYS WILL BE ACCEPTABLE FOR USE ON THIS PROJECT.
- a. PVC (40 & 80).
- b. GALVAIZED RIGID STEEL (GRS).
- c. ELECTRIC METALIC CONDUIT (EMT). d. FLEXIBLE STEEL CONDUIT. (WHERE CONCEALED IN BUILDING CONSTRUCTION)
- e. SEAL—TIGHT FLEX CONDUIT.


SEE NOTE	100	A,12	0/208V,1Ø,4W MCB			(N) P	ANEL		SUR	RFACE MOUNT, NEMA 1		SEE
1,012	30 FULL SIZE PLUG-IN CB SPACES						LOCATION: STORAGE ROOM					
	NQC	D P	ANEL & BRANCH CB'S						WITH	EQUIP'T GND BUS		
	W/	50A	MP MAIN BREAKER									
	CKT #	D	ESCRIPTION	AMP CB # POLE	WIRE SIZE	PHASE A VA	PHASE VA	WIRE SIZE	AMP/CB/POLE	DESCRIPTION	CKT #	
1,2	1	RES	STROOM ERIOR LIGHTING	20/	12	100 2000		10	30 1	HAND DRYER	2	
1,2	3		STROOM FERIOR LIGHTING				100 2000	10	30 / 1	HAND DRYER	4	
1	5		STROOM ERIOR LIGHTING			100 900		12	20/	STORAGE RECEPTACLES	6	
	7	SPA	ARE				100	12	20/	TIMECLOCK CONTROL	8	
	9									SPACE	10	
	11										12	
	13										14	
	15										16	
	17										18	
			CONNECTED L	.OAD (V	A) =	3100	2200					
	25% OF CONTINUOUS LOAD = TOTAL (VA) = TOTAL ÷ 120 VOLT =				50	25						
					3150	2225	_					
					26 A	19 A						

PANEL SCHEDULE NOTES


- 1. LONG CONTINUOUS LOAD (LCL). ADDITIONAL 25% ADDED AT BOTTOM OF PANEL.
- 2. THROUGH EXTERIOR LIGHTING CONTROLS. SEE CONTROL DIAGRAM.

ELECTRICAL PLAN KEYNOTES


- Panel BR
- 2. Timeclock cabinet, See detail X/XX 3. Exterior surface mounted HPS fixture, Failsafe # HSS-505-120 or equal
- 4. Surface mounted fluorescent fixture, Lithonia #LB-232-120-GEB 5. Surface mounted wall bracket fixture, Failsafe #FWW-232-120-EB
- Mount at +84" a.f.f. 6. Junction box for connection to electric hand dryer, verify mounting height.
- 7. Provide 120V connection to plumbing equipment LV transformer
- 8. Provide photocell on roof

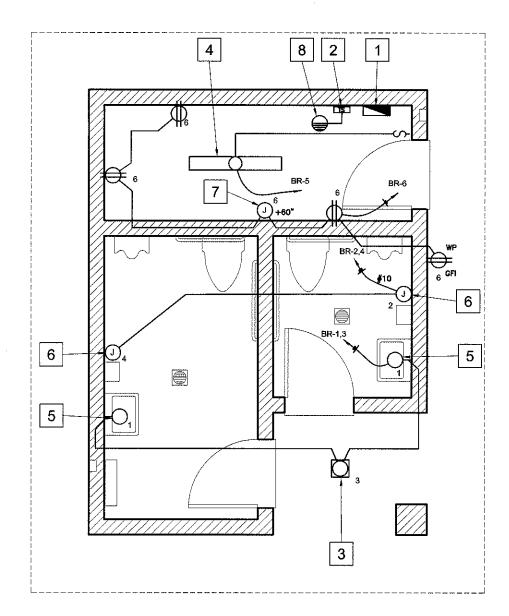




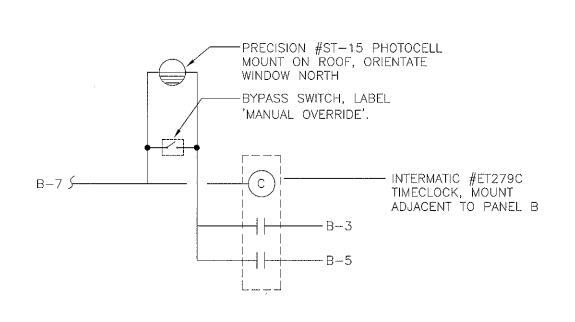

LIGHTING CONTROL DIAGRAM

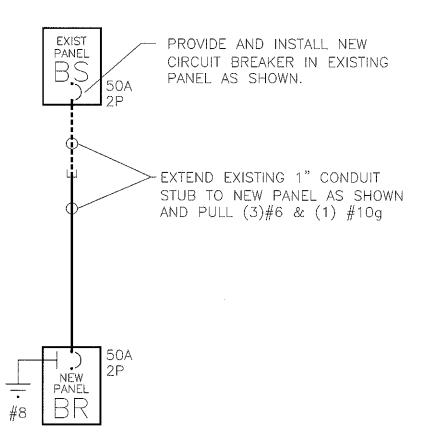

(21) SINGLE LINE DIAGRAM

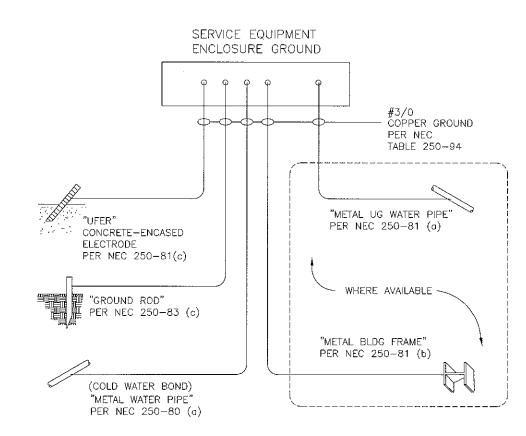

GROUND/BOND DETAIL

10

X 0 O 0

HR OR AN **ESTROOM**

TRIC Y C Z

DESIGNED BY: DRAWN BY: CHECKED BY:

APPROVED BY:

CITY SPECIFICATION NO. SPEC. NO. 99828 SHEET NO.

10

GENERAL NOTES

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 (b) Americans with Disabilities Act (ADA)
- 2. SAFETY: The Electrical Contractor is responsible to maintain all equipment in a safe and responsible manner. Keep dead front equipment in place while equipment is energized. Conduct all construction operations in a safe manner for employees as well as other workpersons or anyone visiting the job site. Provide barriers, flags, tape, etc. as required for safety. The Contractor shall hold all parties harmless of negligent safety practices which may cause injury to others on or near the job site.
- 3. FIRE RATED ASSEMBLIES shall maintain ratings as specified in 1995 California Building Code chapter 7. General Contractor shall provide and install physical enclosure around fixtures, panels, etc. as required. All assemblies to be penetrated shall be installed with applicable through—penetration firestop system as determined by UL classification. Before construction, verify and comply with requirements of local authority having jurisdiction.
- 4. MOUNTING HEIGHTS in inches to centerline above finish floor shall be as follows unless otherwise noted:
- +16" AFF: receptocles, telephone, TV & data outlets. +44" AFF: light switches.
- +48" AFF: fire alarm manual pull stations, T—stats.


 The lower of +80" AFF or 6" below ceiling: fire alarm visuals.
- Before rough—in, verify all mounting heights and exact locations for all equipment electrical connections, stub—ups, receptacles, outlets, etc. with Architect or Owner. Place devices located above counters, shelving, etc. and in bathrooms so as not to conflict with edges of wainscoting, counter splash, shelving, etc. Architectural sheets shall govern.
- 5. LABEL panels, cabinets, backboards, main devices, safety switches, contactors and other specifically designated equipment shown on plans. Use engraved laminated plastic nameplates attached by screws or rivets. Neatly and indelibly label conduit destinations on both visible ends of conduit runs where conduits terminate at designated enclosures, structures or equipment (including pull and splice boxes). Correct existing panel directories and field—labeled designations to reflect new conditions.
- 6. EQUIPMENT GROUNDING CONDUCTORS shall be installed in ALL power system raceways.
- 7. MINIMUM CONDUIT SIZE shall be 1/2" except use minimum 3/4" for underslab homeruns and below grade outside of building exterior walls. Run exposed conduit square and plumo with building lines.
- 8. BEFORE CONSTRUCTION, PROVIDE SUBMITTALS of proposed products for Owner review and approval. All equipment and materials shall be new and listed, labeled or certified for its use by a Nationally Recognized Testing Laboratory (NRTL) as recognized by the US Dept. of Labor, Occupational Safety and Health Administration. The quality and suitability of all products and materials shall conform to the standards and practices of this trade.
- 9. THE ELECTRICAL PLANS indicate the general layout and arrangement; exact locations shall be determined by the architectural drawings and field conditions. Field verify all conditions and modify as required to satisfy design intent. Maintain all required working clearances.
- 10. DISCREPANCIES shall be brought immediately to the attention of the Architect for clarification.

 Any changes shall be approved by the Architect. Prior to rough—in, refer to architectural plans which shall take precedence over electrical plans with respect to locations.
- 11. PROFESSIONALISM AND APPEARANCE of all installations shall be in accordance with accepted practices of this trade. Installation methods shall conform to manufacturers' specifications. The Contractor shall provide the job with qualified journeymen and helpers in this trade for the duration of the job. It is the Contractor's responsibility to communicate with and keep the job superintendent appraised of changes or clarifications, etc.
- 12. THE INTENT OF THESE SPECIFICATIONS is to establish a standard of quality for materials and equipment. Therefore, some items are identified by manufacturer or trade name designation. Substitutions shall be subject to the Architect's approval. Samples of the proposed and substitute materials may be required for inspection prior to approval. Costs, if any, for evaluation of substitutions shall be the Contractor's responsibility. The decision of the Architect shall be final. Where the substitution will affect other trades, coordinate all changes with those trades concerned and pay any additional costs incurred by them as a result of this substitution. Approval of substitutions shall not relieve the Contractor from providing an operational system in accordance with all applicable codes and ordinances.
- 13. STORAGE OF EQUIPMENT for the job is the responsibility of the Electrical Contractor and shall be scheduled for delivery to the site as the equipment is required. Damage to the equipment delivered to the site or in transport to the job shall be the responsibility of the Electrical Contractor.
- 14. USE STEEL OUTLET BOXES only.
- 15. SWITCHES AND RECEPTACLES shall be 20 amp.
- 16. ALL POWER SYSTEM CONDUCTORS shall be copper with type THHN/THWN insulation, INSTALLED IN ALL RACEWAYS.
- 17. PROVIDE NEAT AND ACCURATE FIELD RECORD DRAWINGS to Owner upon completion of work.
- 18. GUARANTEES: All equipment and labor shall be guaranteed and warranted free of defects, unless otherwise stated to be more restrictive, for a period of one year from the date of final acceptance by the Owner. A written warranty shall be presented to the Architect at the time of completion prior to final acceptance. Equipment deemed to be damaged, broken or failed shall be repaired or replaced at no additional cost to the Owner.
- 19. THE FOLLOWING RACEWAYS WILL BE ACCEPTABLE FOR USE ON THIS PROJECT.
- a. PVC (40 & 80).
- b. GALVAIZED RIGID STEEL (GRS).c. ELECTRIC METALIC CONDUIT (EMT).
- d. FLEXIBLE STEEL CONDUIT. (WHERE CONCEALED IN BUILDING CONSTRUCTION)
 e. SEAL—TIGHT FLEX CONDUIT.

SEE	100A,120/208V,10,4W MCB 30 FULL SIZE PLUGHIN CB SPACES NOOD PANEL & BRANCH CB'S W/ 50AMP MAIN BREAKER				(N) PANEL				SURFACE MOUNT, NEMA 1		
								LOCATION: STORAGE ROOM WITH EQUIP'T OND BUS			
	CKT #	DESCRIPTION		WIRE SIZE	PHASE VA	PHASE "	WIRE SIZE	TAMP/ICB	DESCRIPTION	ickt #	
1,2	1	RESTROOM INTERIOR LIGHTING	20/	12	100 2000		10	30/	MAND DRYER	2	
1,2	3	RESTROOM EXTERIOR LIGHTING				100 2000	10	30/ 1	HAND DRYER	4	
1	5	RESTROOM INTERIOR LIGHTING	-		100 900		12	20/	STORAGE RECEPTABLES	6	
	7	SPARE				100	12	20/	TIMECLOCK CONTROL	8	
	9						ļ		SPACE	10	
	1 1									12	
	13						1			14	
	15							ļ		16	
	17						1			118	
		CONNECTED L	CAD (V.	A) =	3100	2200		<u> </u>			
	25% OF CONTINUOUS LOAD = TOTAL (VA) =				50	25	-				
					3150	2225	<u> </u>				
		TOTAL :	_1 -	26 A	19 A	<u> </u>					

PANEL SCHEDULE NOTES

- 1. LONG CONTINUOUS LOAD (LCL). ADDITIONAL 25% ADDED AT BOTTOM OF PANEL.
- 2. THROUGH EXTERIOR LIGHTING CONTROLS. SEE CONTROL DIAGRAM.

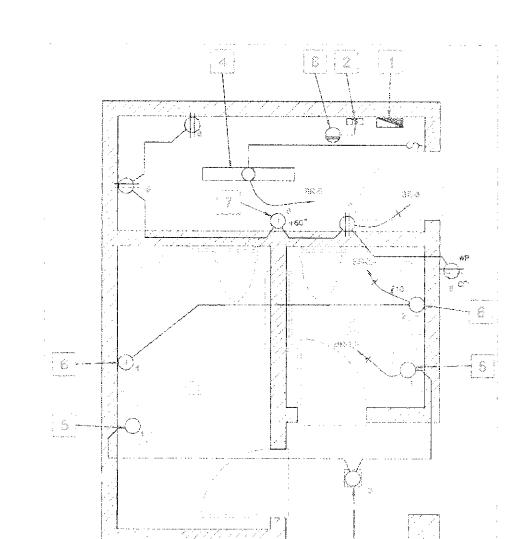

ELECTRICAL PLAN KEYNOTES

3. Exterior surface mounted HPS fixture, Fallcale # HSS-365-120 or equal

Sundion box for connection to electric hand dryer vesify mounting height.

4. Surface mounted (lucrescent fixture, Lithonia #LB-232-120-GEB

Provide 126V connection to plumbing equipment LV transformer.

5. Stafface mounted well brecker fixture. Partisele #FWW-7015-120/E8


Timedlock pabinet, See detail X/xX

Mount at +84" a.f.f.


8. Provide photopell on roof

1. Panel SR




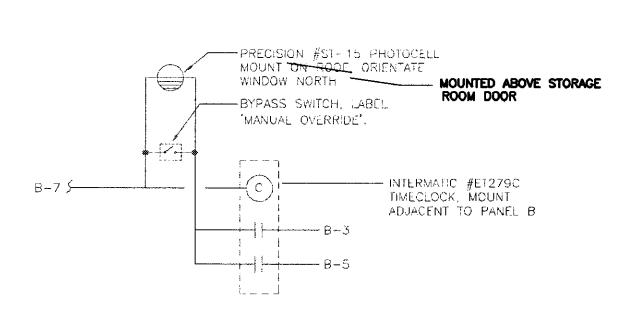

31 LIGHTING CONTROL DIAGRAM

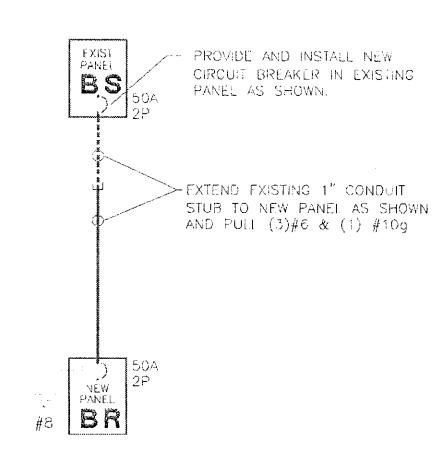

SINGLE LINE DIAGRAM

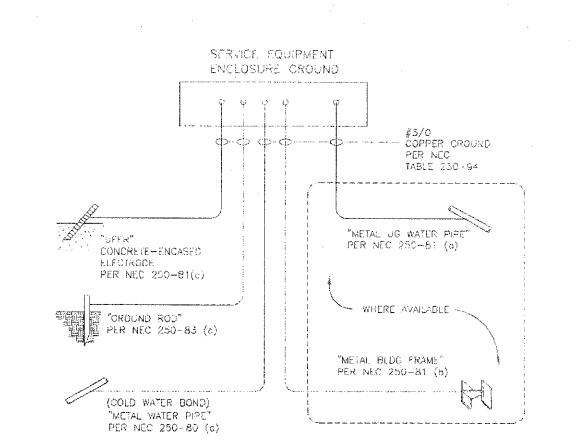

GROUND/BOND DETAIL

RECORD DRAWING
DATE: 6/7/02 BY: SR

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Assault and

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BDF

JOP

SPEC. NO. 99828